

# Lower Thames Crossing

2.9 Engineering Drawings and Sections Volume G (A122 LTC M25 junction plan and profiles) (Tracked changes version)

APFP Regulation 5(2)(o) and 6(2)

Infrastructure Planning (Applications: Prescribed Forms and Procedure) Regulations 2009

Volume 2

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## **Revision History**

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1.0	31 October 2022	DCO Application
2.0	11 December 2023	Deadline 9

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## **Lower Thames Crossing**

## 2.9 Engineering Drawings and Sections Volume G (A122 LTC M25 junction plan and profiles) (Tracked changes version)

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## 1 Introduction

- 1.1.1 This document is submitted to the Planning Inspectorate on behalf of the Secretary of State in relation to an application made by National Highways (the Applicant) under section 37 of the Planning Act 2008.
- 1.1.2 The application is for the grant of development consent for the A122 Lower Thames Crossing. Should development consent be granted, the draft A122 (Lower Thames Crossing) Development Consent Order (Application Document 3.1) (the draft Order) will be made by the Secretary of State (subject to any modifications considered appropriate).
- 1.1.3 This document comprises part of the suite of application documentation and is included in the application to comply with Regulations 5(2)(o) and 6(2) of the Infrastructure Planning (Applications: Prescribed Forms and Procedure) Regulations 2009 (the 2009 Regulations), which require:
  - a. 5(2)(o) 'any other plans, drawings and sections necessary to describe the proposals for which development consent is sought, showing details of design, external appearance, and the preferred layout of buildings or structures, drainage, surface water management, means of vehicular and pedestrian access, any car parking to be provided, and means of landscaping.
  - b. 6(2) If the application is for highway related development or for the construction or alteration of a railway, it must be accompanied by section drawings to suitable horizontal and vertical scales, which show, by reference to Ordnance Survey or Chart datum:
  - c. the levels of the proposed works, including in particular and where relevant:
    - i. ground levels;
    - ii. the height of every proposed bridge, viaduct, aqueduct, embankment and elevated guideway;
    - iii. the depth of every proposed cutting and tunnel;
    - iv. the levels of the bed of any tidal waters or inland waterway in which it is proposed that any works should be situated;
    - the height of every structure or device (including a cable, but not catenary and related equipment) intended to be erected above, on or below the surface of, or on or beneath the bed of tidal waters or an inland waterway; and
    - vi. drainage outfall details for highways;

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- 1.1.4 The purpose of the Engineering Drawings and Sections Plans is to show the key features of the Project for which development consent is sought. The set shows details of the proposed road plan and longitudinal profile including the ground levels, the height of certain structures and embankments, the depth of proposed cuttings and tunnel, and the indicative location and level of drainage outfall features.
- 1.1.6 For each section, the Applicant has provided a key plan of the corresponding geographical area that provides the sheet number and a description of the associated road works to help with its identification within the set. It is important to note that the plans are numbered in each of the aforementioned sections and that the numbering system does not apply to the set as whole.
- 1.1.7 The key plans use a smaller scale than that prescribed in Regulation 5(3) of the 2009 Regulations so that the Project or the section of the Project can be represented in a single sheet plan. The scales in the key plans vary from 1:50000 to 1:5000. The remaining sheets in the set containing the plan and profiles and the cross sections have been prepared at a horizontal scale of 1:2500 and a vertical scale of 1:250.
- 1.1.8 As this document has been informed by and is part of the application documentation it should be read alongside the other application documents. In particular, the plans should be read alongside the Works Plans (Application Document 2.6) and Schedule 1 of the draft Order (Application Document 3.1). Article 6 of the draft Order should also be referred to as it provides the reference points for the application of the upwards and downwards vertical limits of deviation applicable to the elements of the works.
- 1.1.9 Numbered works shown in the Engineering Drawings and Sections Plans are consistent with the information presented in the Works Plans (Application Document 2.6) and Schedule 1 of the draft Order (Application Document 3.1). Further details of the proposed bridges and tunnel structures are provided in the Structures Plans (Application Document 2.13).
- 1.1.10 The information shown on the plans is commensurate with the preliminary design status of the Project. The detailed design will be in accordance with the extent of the defined limits of deviation provided and any approval required under the DCO requirements set out in Schedule 2 of the draft Order (Application Document 3.1).
- 1.1.11 The lateral limits of deviation for the works are shown in the Works Plans (Application Document 2.6) and in the Tunnel Limits of Deviation (Application Document 2.15); article 6 of the draft Order establishes the vertical limits of deviation. Further information about the limits of deviation is provided in the Introduction to the Application (Application Document 1.3).
- 1.1.6 The Engineering Drawings and Sections show the Order Limits. In this plan set, 'the Order Limits' mean the limits of lands to be acquired or used, permanently or temporarily, within which the authorised development may be carried out (see article 2 of the draft Order (Application Document 3.1)).
- 1.1.7 To ensure that the file size of this document does not exceed the 50MB limit prescribed by the Planning Inspectorate, the set has been split into eight volumes:

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- a. Volume A contains the A122 Lower Thames Crossing Plan and Profiles;
- b. Volume B contains the A122 Lower Thames Crossing Cross Sections;
- c. Volume C contains the A2/M2 Plan and Profiles and A2 Mainline Plan and Profiles;
- d. Volume D contains the A122 Lower Thames Crossing/A2 Junction Plan and Profiles;
- e. Volume E contains the South Portal Plan and Profiles and Tilbury Plan and Profiles;
- f. Volume F contains the A13 Junction Plan and Profile;
- g. Volume G contains the A122 Lower Thames Crossing/M25 Junction Plan; and
- h. Volume H contains the Overhead Diversion Route and Pylon general arrangements.
- 1.1.12 <u>These plans have been updated for Deadline 9 to include all agreed proposed</u> **Formatte** changes and amendments throughout Examination.

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# 2 Schedule of Plans included in this application document

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A122 LTC PLAN AND PROFILES REGULATION 5(2)(0) AND 6(2) KEY PLAN	TR010032/APP/2.9	P0 <u>5</u> ,	Deleted: 1
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Planning Inspectorate Scheme Ref: TR010032 Application Document Ref: TR010032/APP/2.9 DATE: December 2023 DEADLINE: 9


Volume 2


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A122 LTC/M25 JUNCTION REGULATION 5(2)(0) AND 6(2) SHEET 14	TR010032/APP/2.9	P0 <u>2</u>	Deleted: 1
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OVERHEAD DIVERSION ROUTE REGULATION 5(2)(0) AND 6(2) PYLON LAYOUT	TR010032/APP/2.9	P0 <u>2</u>	Deleted: 1
OVERHEAD DIVERSION ROUTE REGULATION 5(2)(o) AND 6(2) SHEET 1	TR010032/APP/2.9	P0 <u>2</u>	Deleted: 1
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OVERHEAD DIVERSION ROUTE REGULATION 5(2)(0) AND 6(2) SHEET 3	TR010032/APP/2.9	P0 <u>2</u>	Deleted: 1
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PYLON GENERAL ARRANGEMENT REGULATION 5(2)(0) AND 6(2) SHEET 1	TR010032/APP/2.9	P0 <u>2</u>	Deleted: 1
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PYLON GENERAL ARRANGEMENT REGULATION 5(2)(0) AND 6(2) SHEET 3 - L7c D E12	TR010032/APP/2.9	P0 <u>2</u>	Deleted: 1
PYLON GENERAL ARRANGEMENT REGULATION 5(2)(0) AND 6(2) SHEET 4 - L7c D30 E12	TR010032/APP/2.9	P0 <u>2</u>	Deleted: 1
Planning Inspectorate Scheme Ref: TR010032 Application Document Ref: TR010032/APP/2.9 DATE: December 2023 DEADLINE: 9 12	Uncontrolled when printed – C National Highways Limited – a	Copyright © - 2023 all rights reserved	

Application Document Ref: DATE: December 2023 DEADLINE: 9

Volume 2

Document Title	Document Number	Revision	1
PYLON GENERAL ARRANGEMENT REGULATION 5(2)(0) AND 6(2) SHEET 5 - L7c D E3	TR010032/APP/2.9	P0 <u>2</u>	Deleted: 1
PYLON GENERAL ARRANGEMENT REGULATION 5(2)(0) AND 6(2) SHEET 6 - L7c D30 E9	TR010032/APP/2.9	P0 <mark>2</mark>	Deleted: 1
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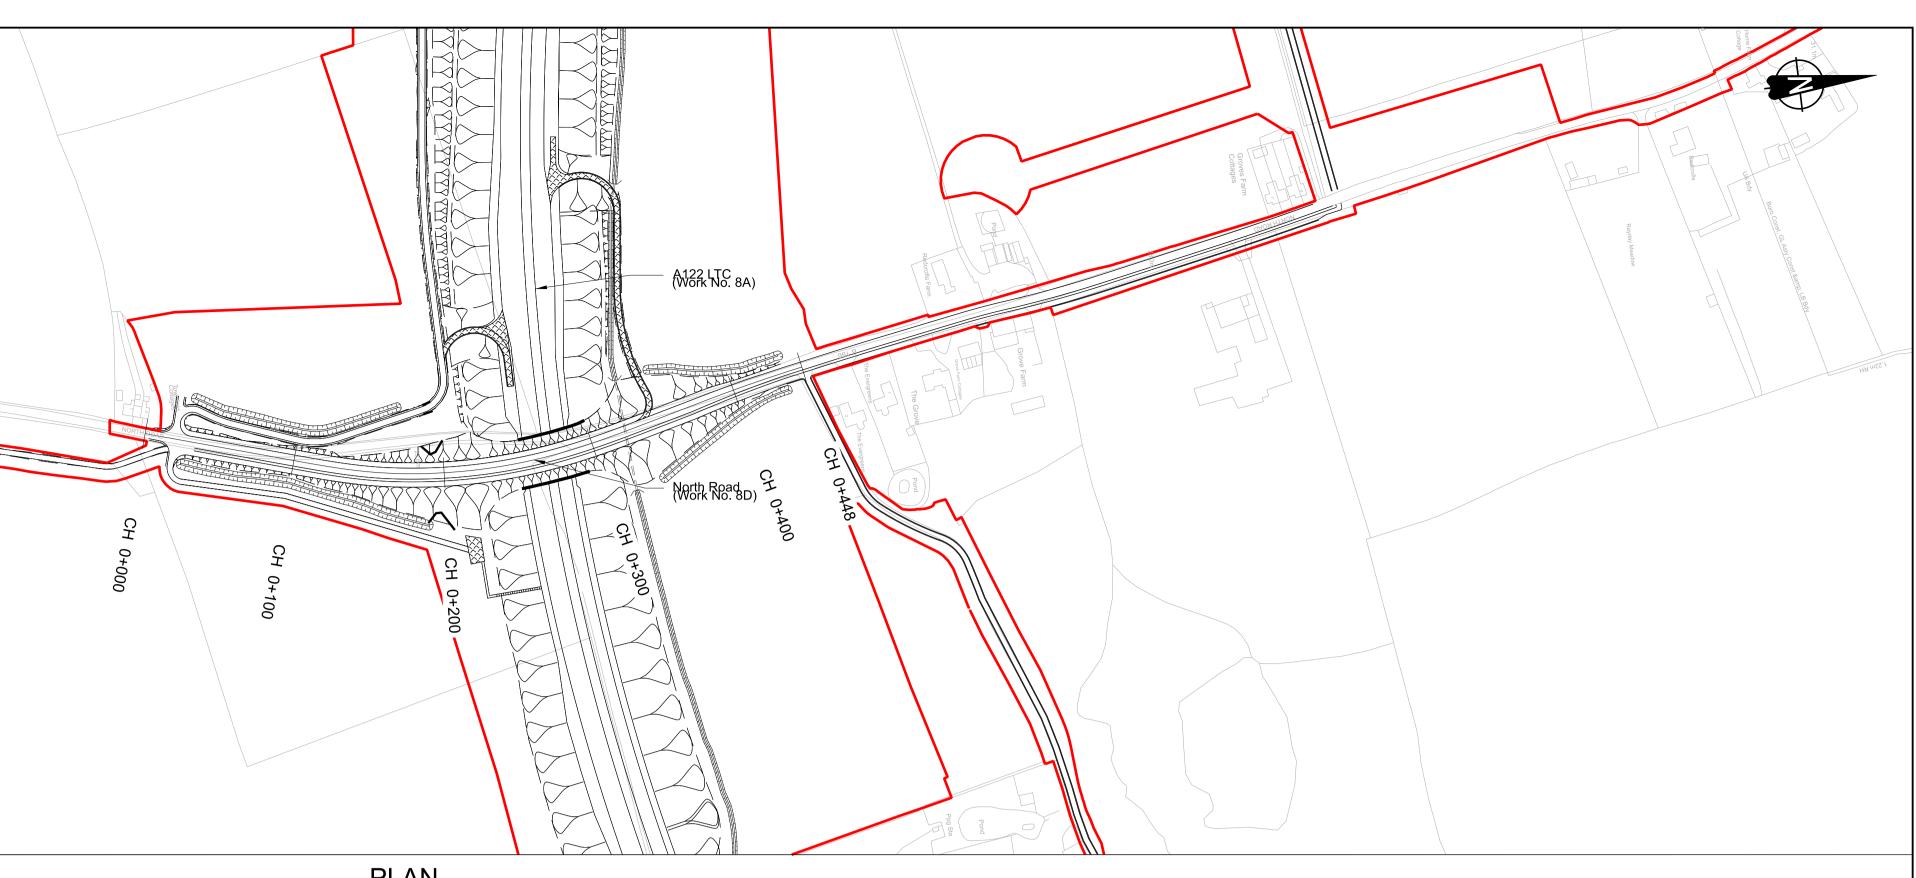

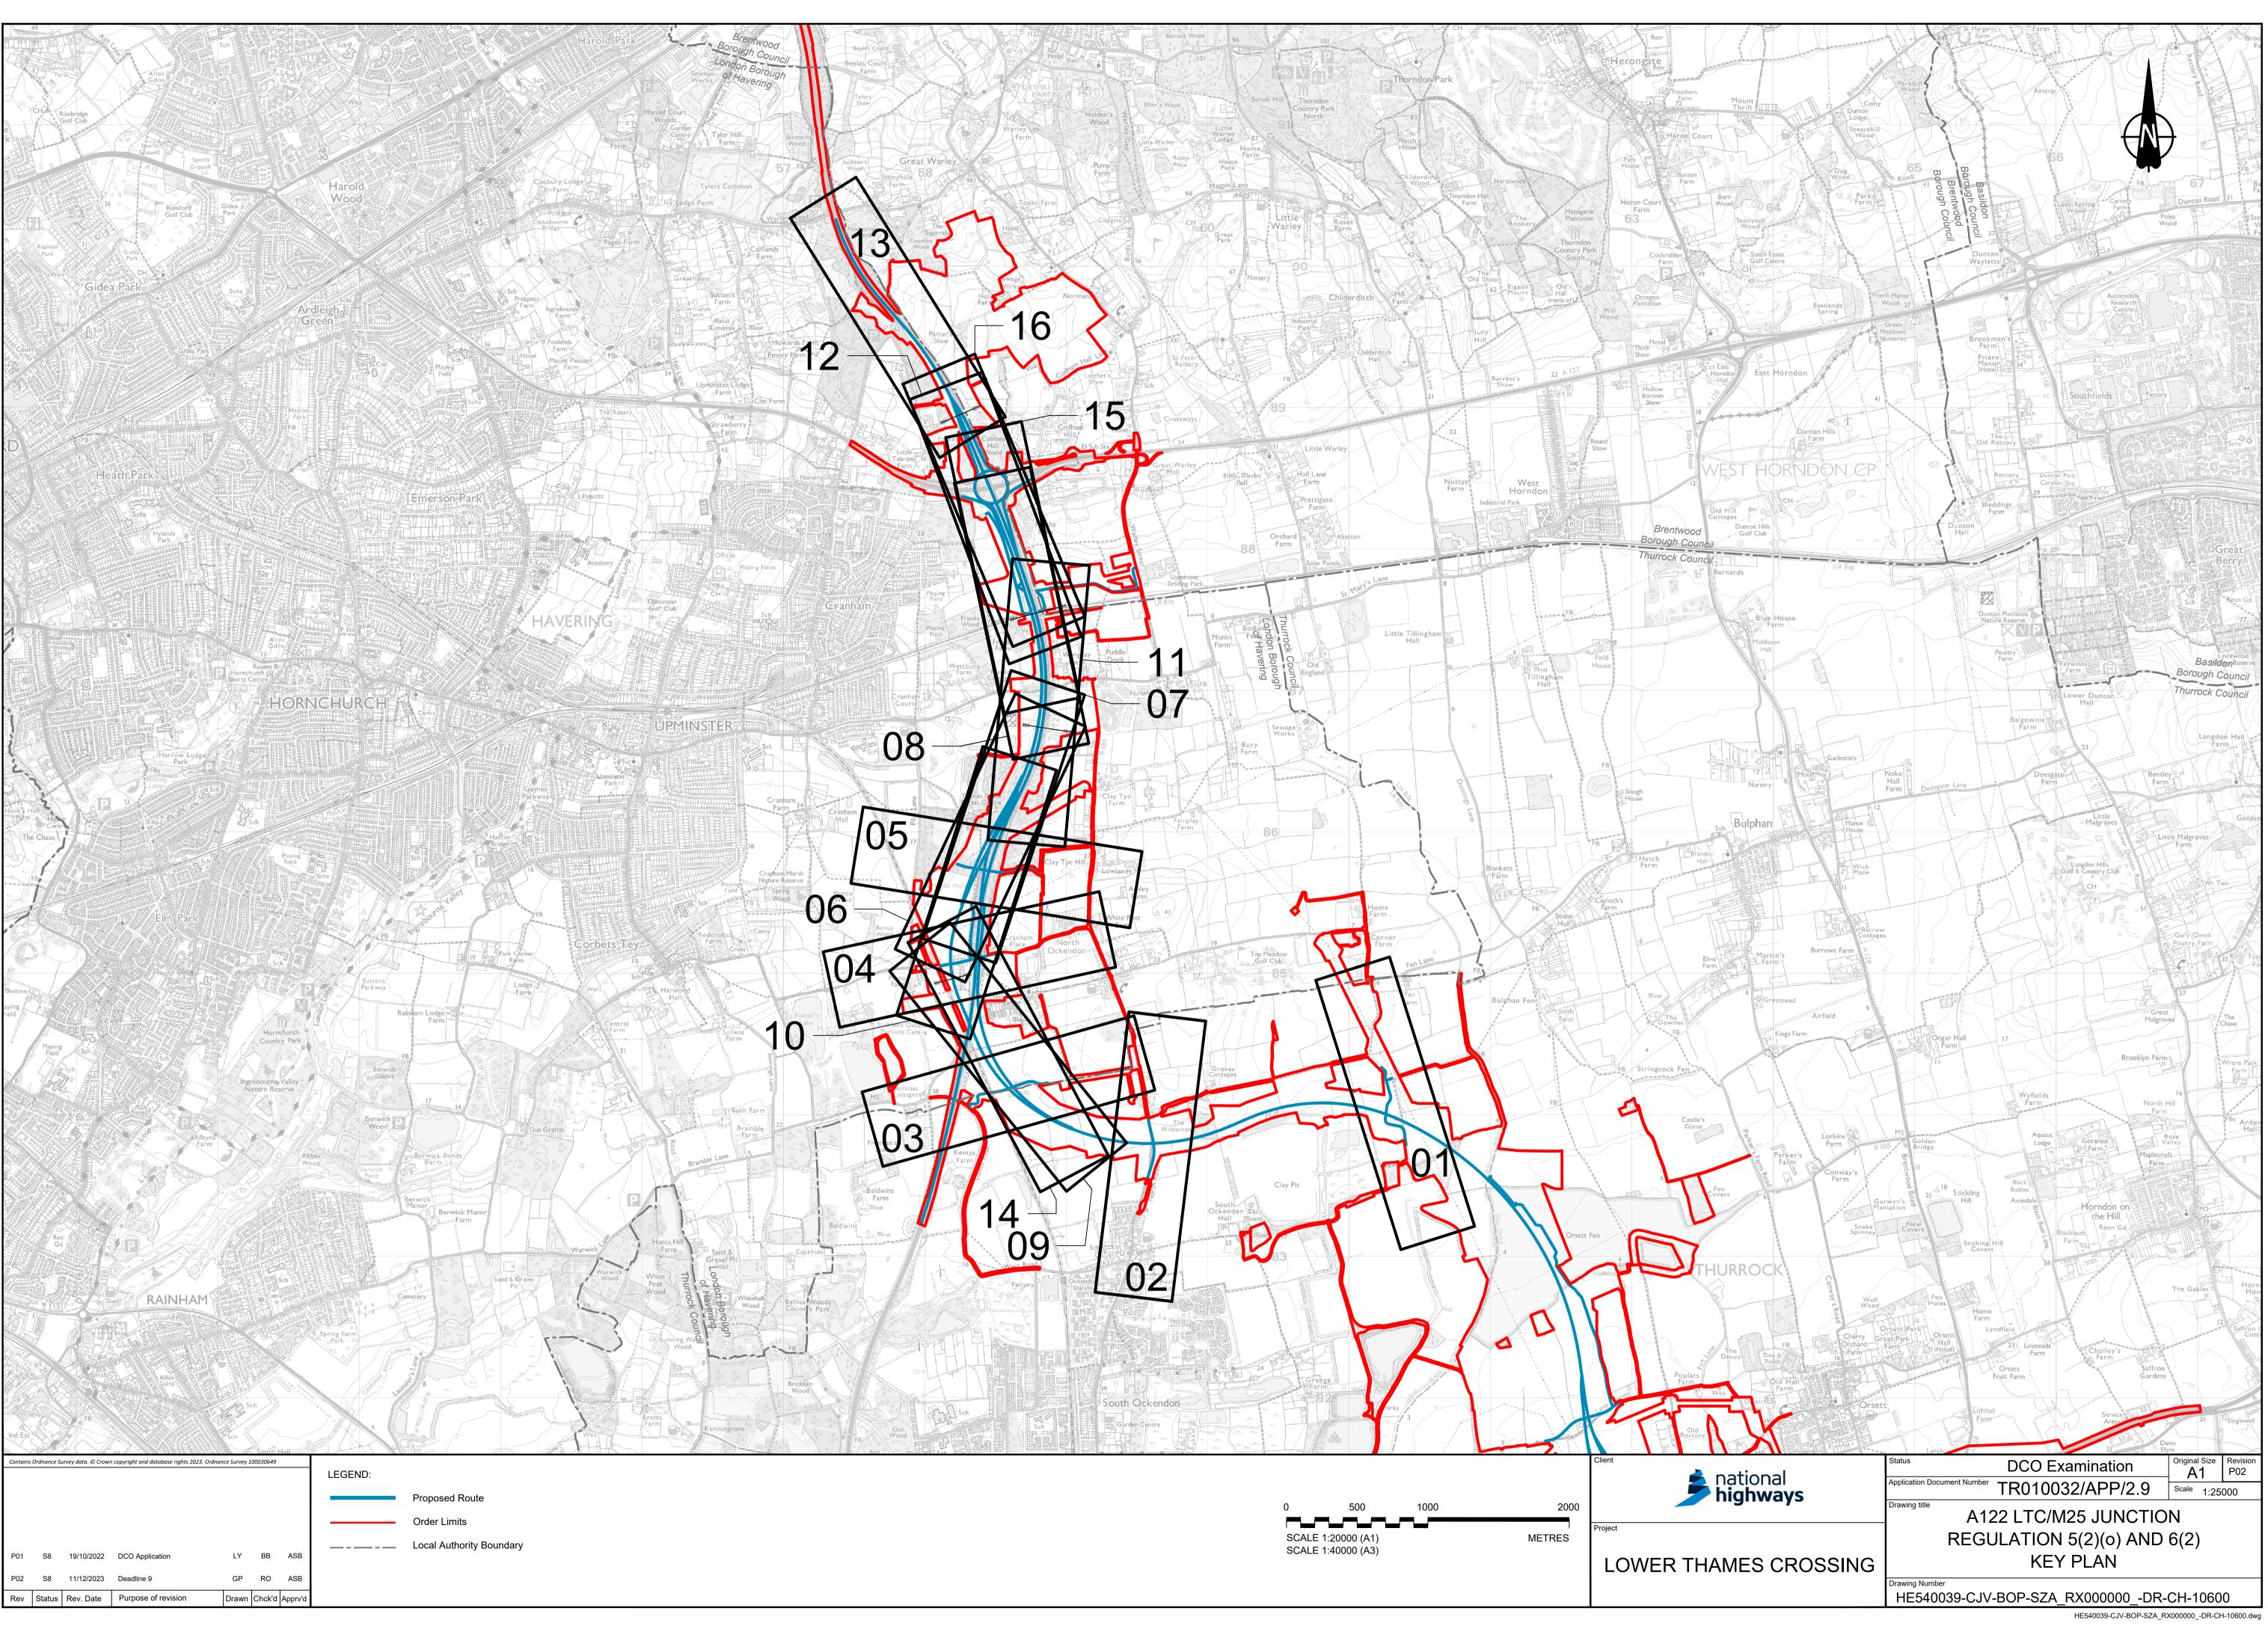
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Rev. Date	Purpose of revision	Drawn	Chck'd	Apprv'd	

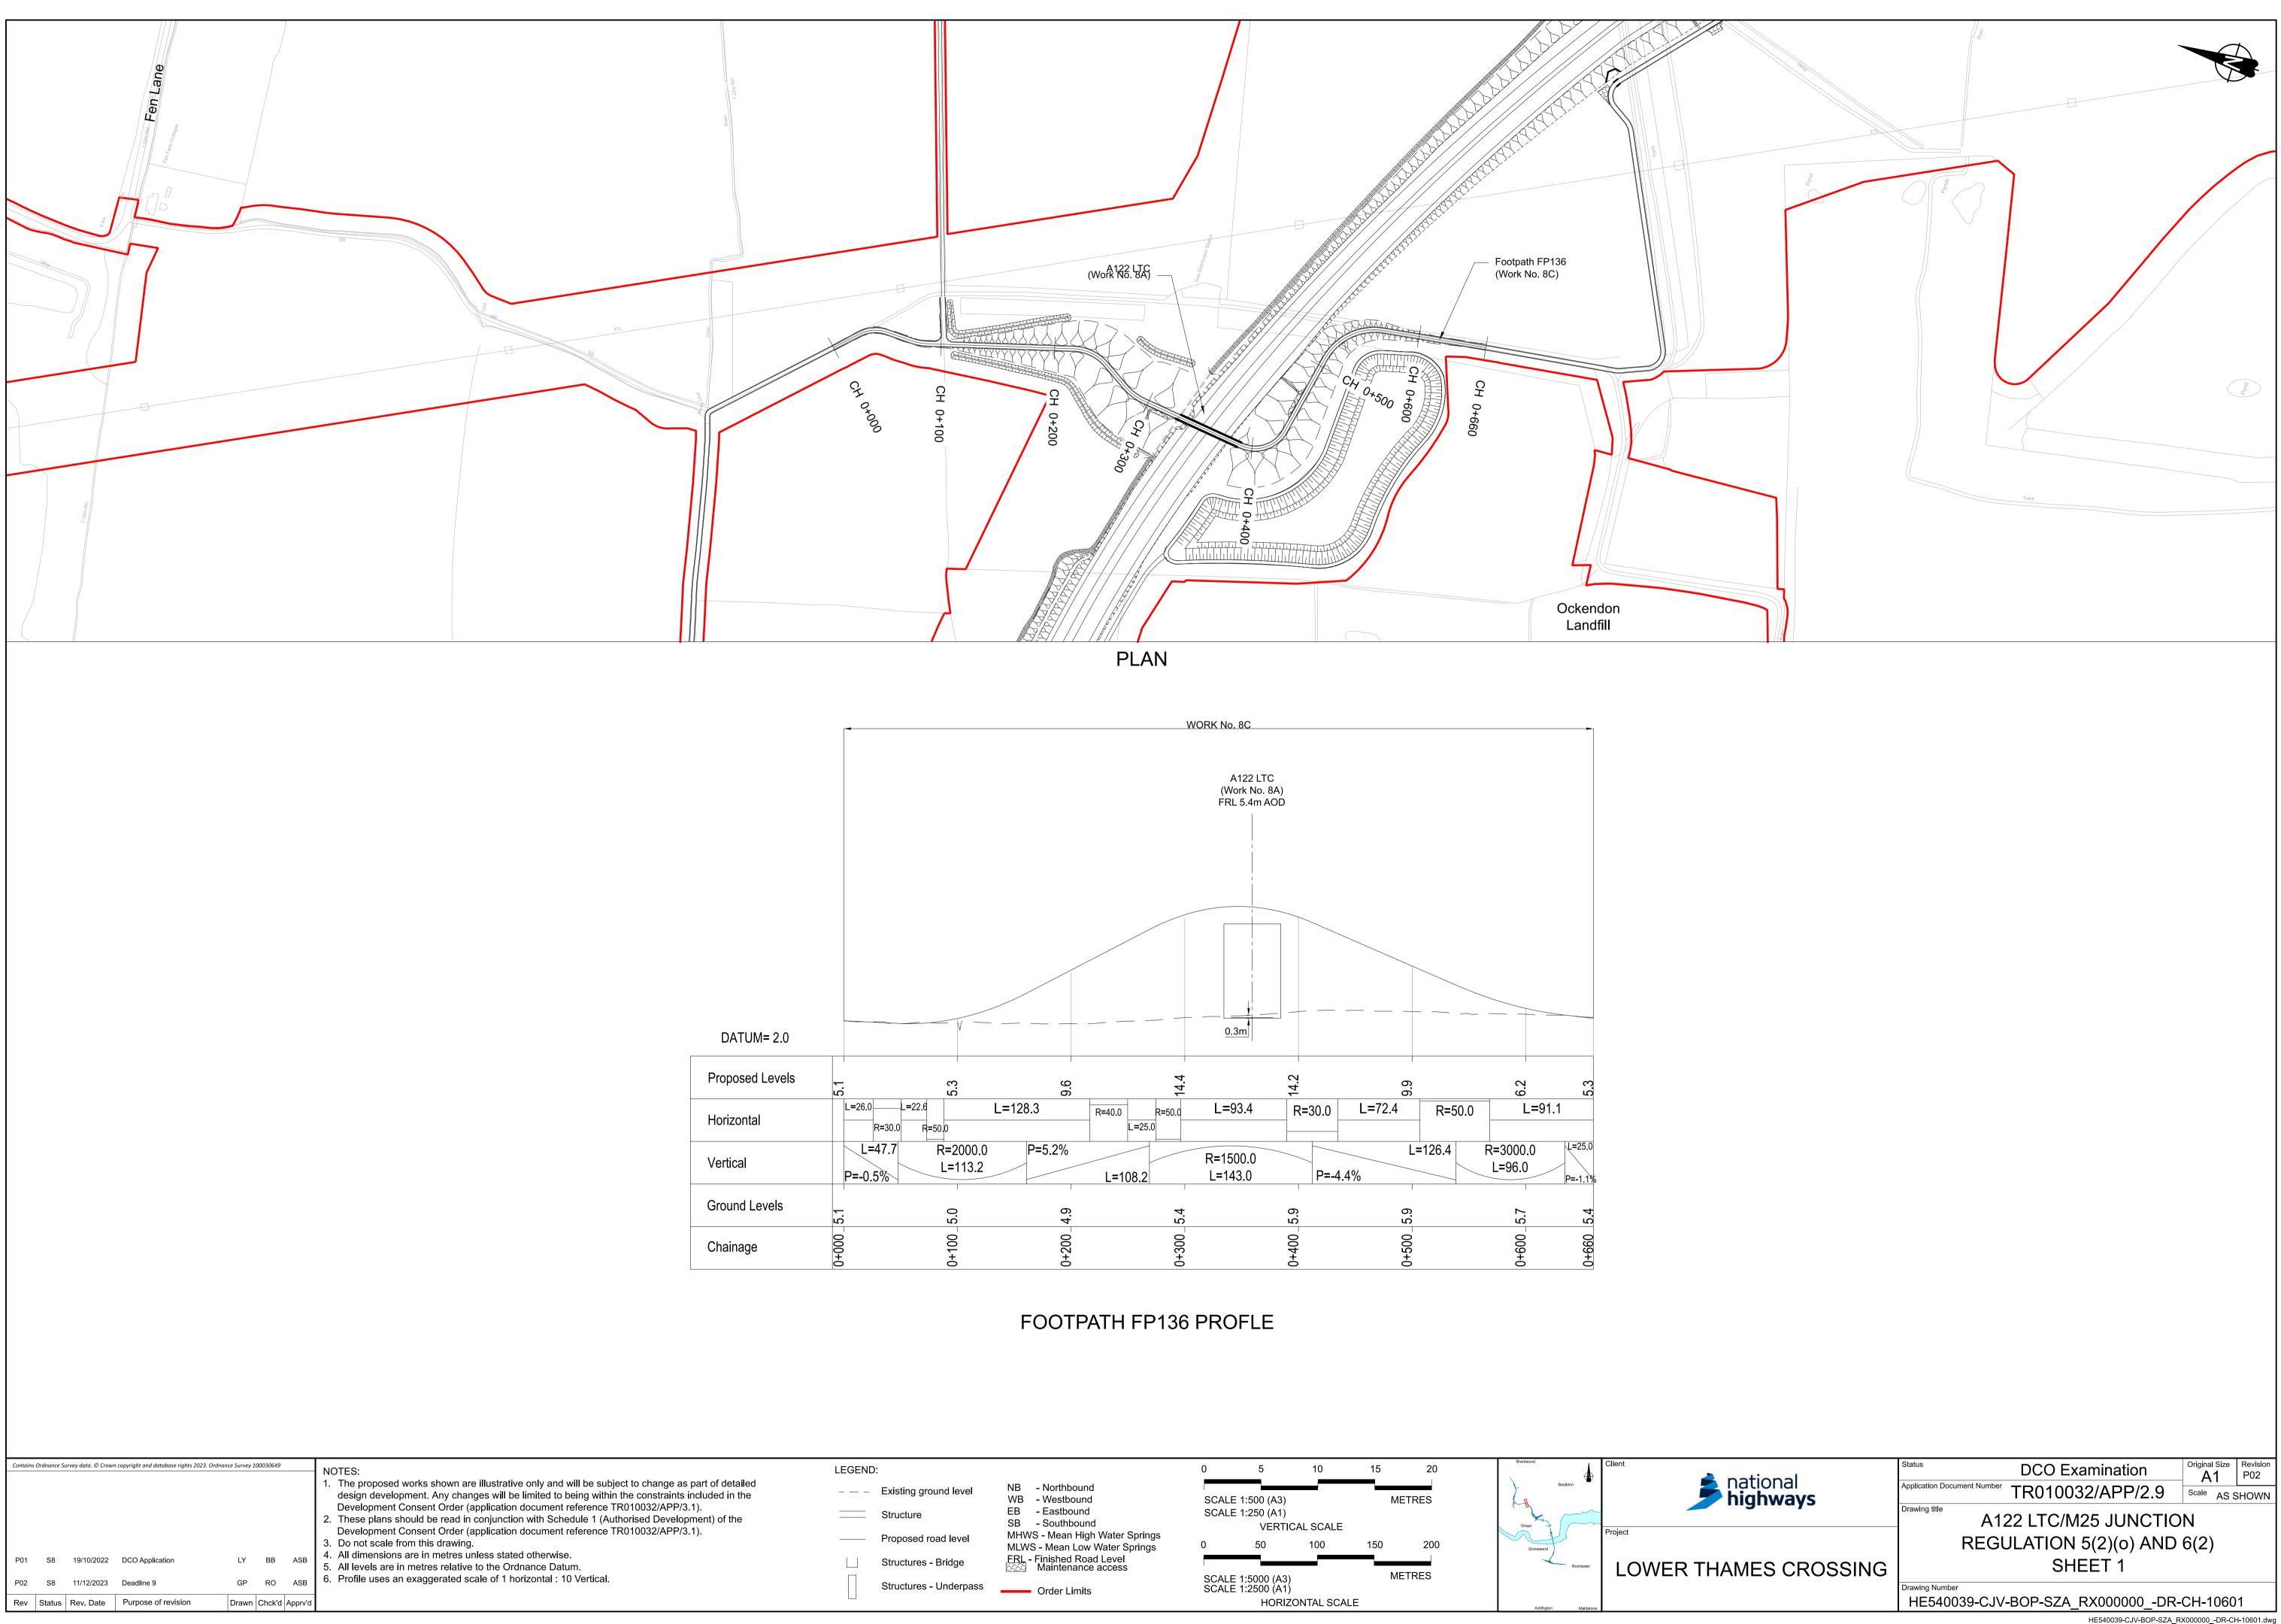
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ational <b>ighways</b>	Application Document Number TR010032/APP/2.9	Scale AS S	HOWN
.9	Drawing title A122 LTC/M25 JUNCTIO	N	
	REGULATION 5(2)(o) AND	6(2)	
MES CROSSING	SHEET 1		
	Drawing Number HE540039-CJV-BOP-SZA_RX000000DR-0	CH-1060	1

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Contains Ordnance Survey data. © Crown copyright and database rights 2023. Ordnance Survey 100030649 NOTES:	
<ol> <li>The proposed works shown are illustrative only and will be subject to change as part of detailed design development. Any changes will be limited to being within the constraints included in the Development Consent Order (application document reference TR010032/APP/3.1).</li> <li>These plans should be read in conjunction with Schedule 1 (Authorised Development) of the</li> </ol>	
Development Consent Order (application document reference TR010032/APP/3.1). 3. Do not scale from this drawing. 4. All dimensione are in metros unloss stated etherwise.	
P01 S8 19/10/2022 DCO Application LY BB ASB 4. All dimensions are in metres unless stated otherwise. 5. All levels are in metres relative to the Ordnance Datum. 6. Profile uses an exaggerated scale of 1 horizontal : 10 Vertical.	


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P02	S8	11/12/2023	Deadline 9	GP	RO	ASB	6. Profile uses an exaggerated scale of 1 horizontal : 10 Vertical.
PUT	58	19/10/2022	DCO Application	LY	вв	ASB	5. All levels are in metres relative to the Ordnance Datum.




PLAN

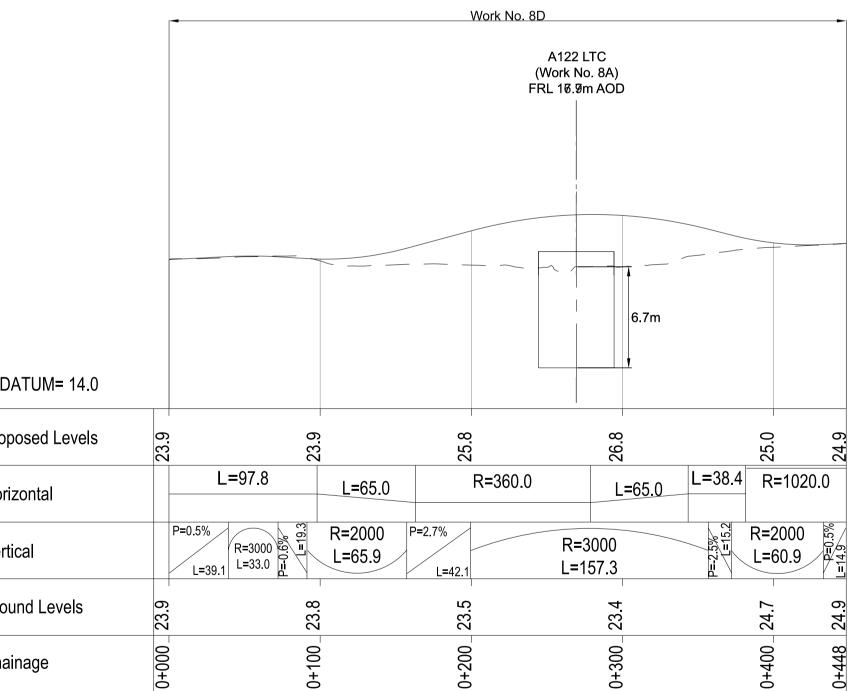

# NORTH ROAD PROFILE

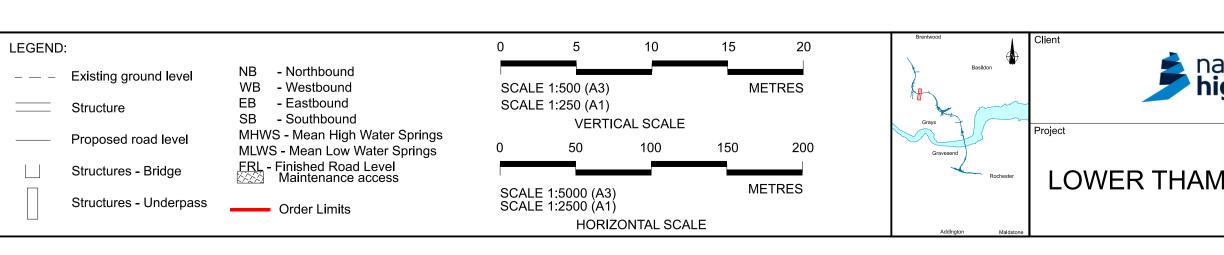


ational	Status DCO Examination	Original Size <b>A1</b>	Revision P02
ational <b>ighways</b>	Application Document Number TR010032/APP/2.9	Scale AS S	HOWN
·9····a,5	Drawing title A122 LTC/M25 JUNCTIO	N	
	REGULATION 5(2)(o) AND	6(2)	
MES CROSSING	SHEET 2		
	Drawing Number HE540039-CJV-BOP-SZA_RX000000DR-0	CH-1060	2

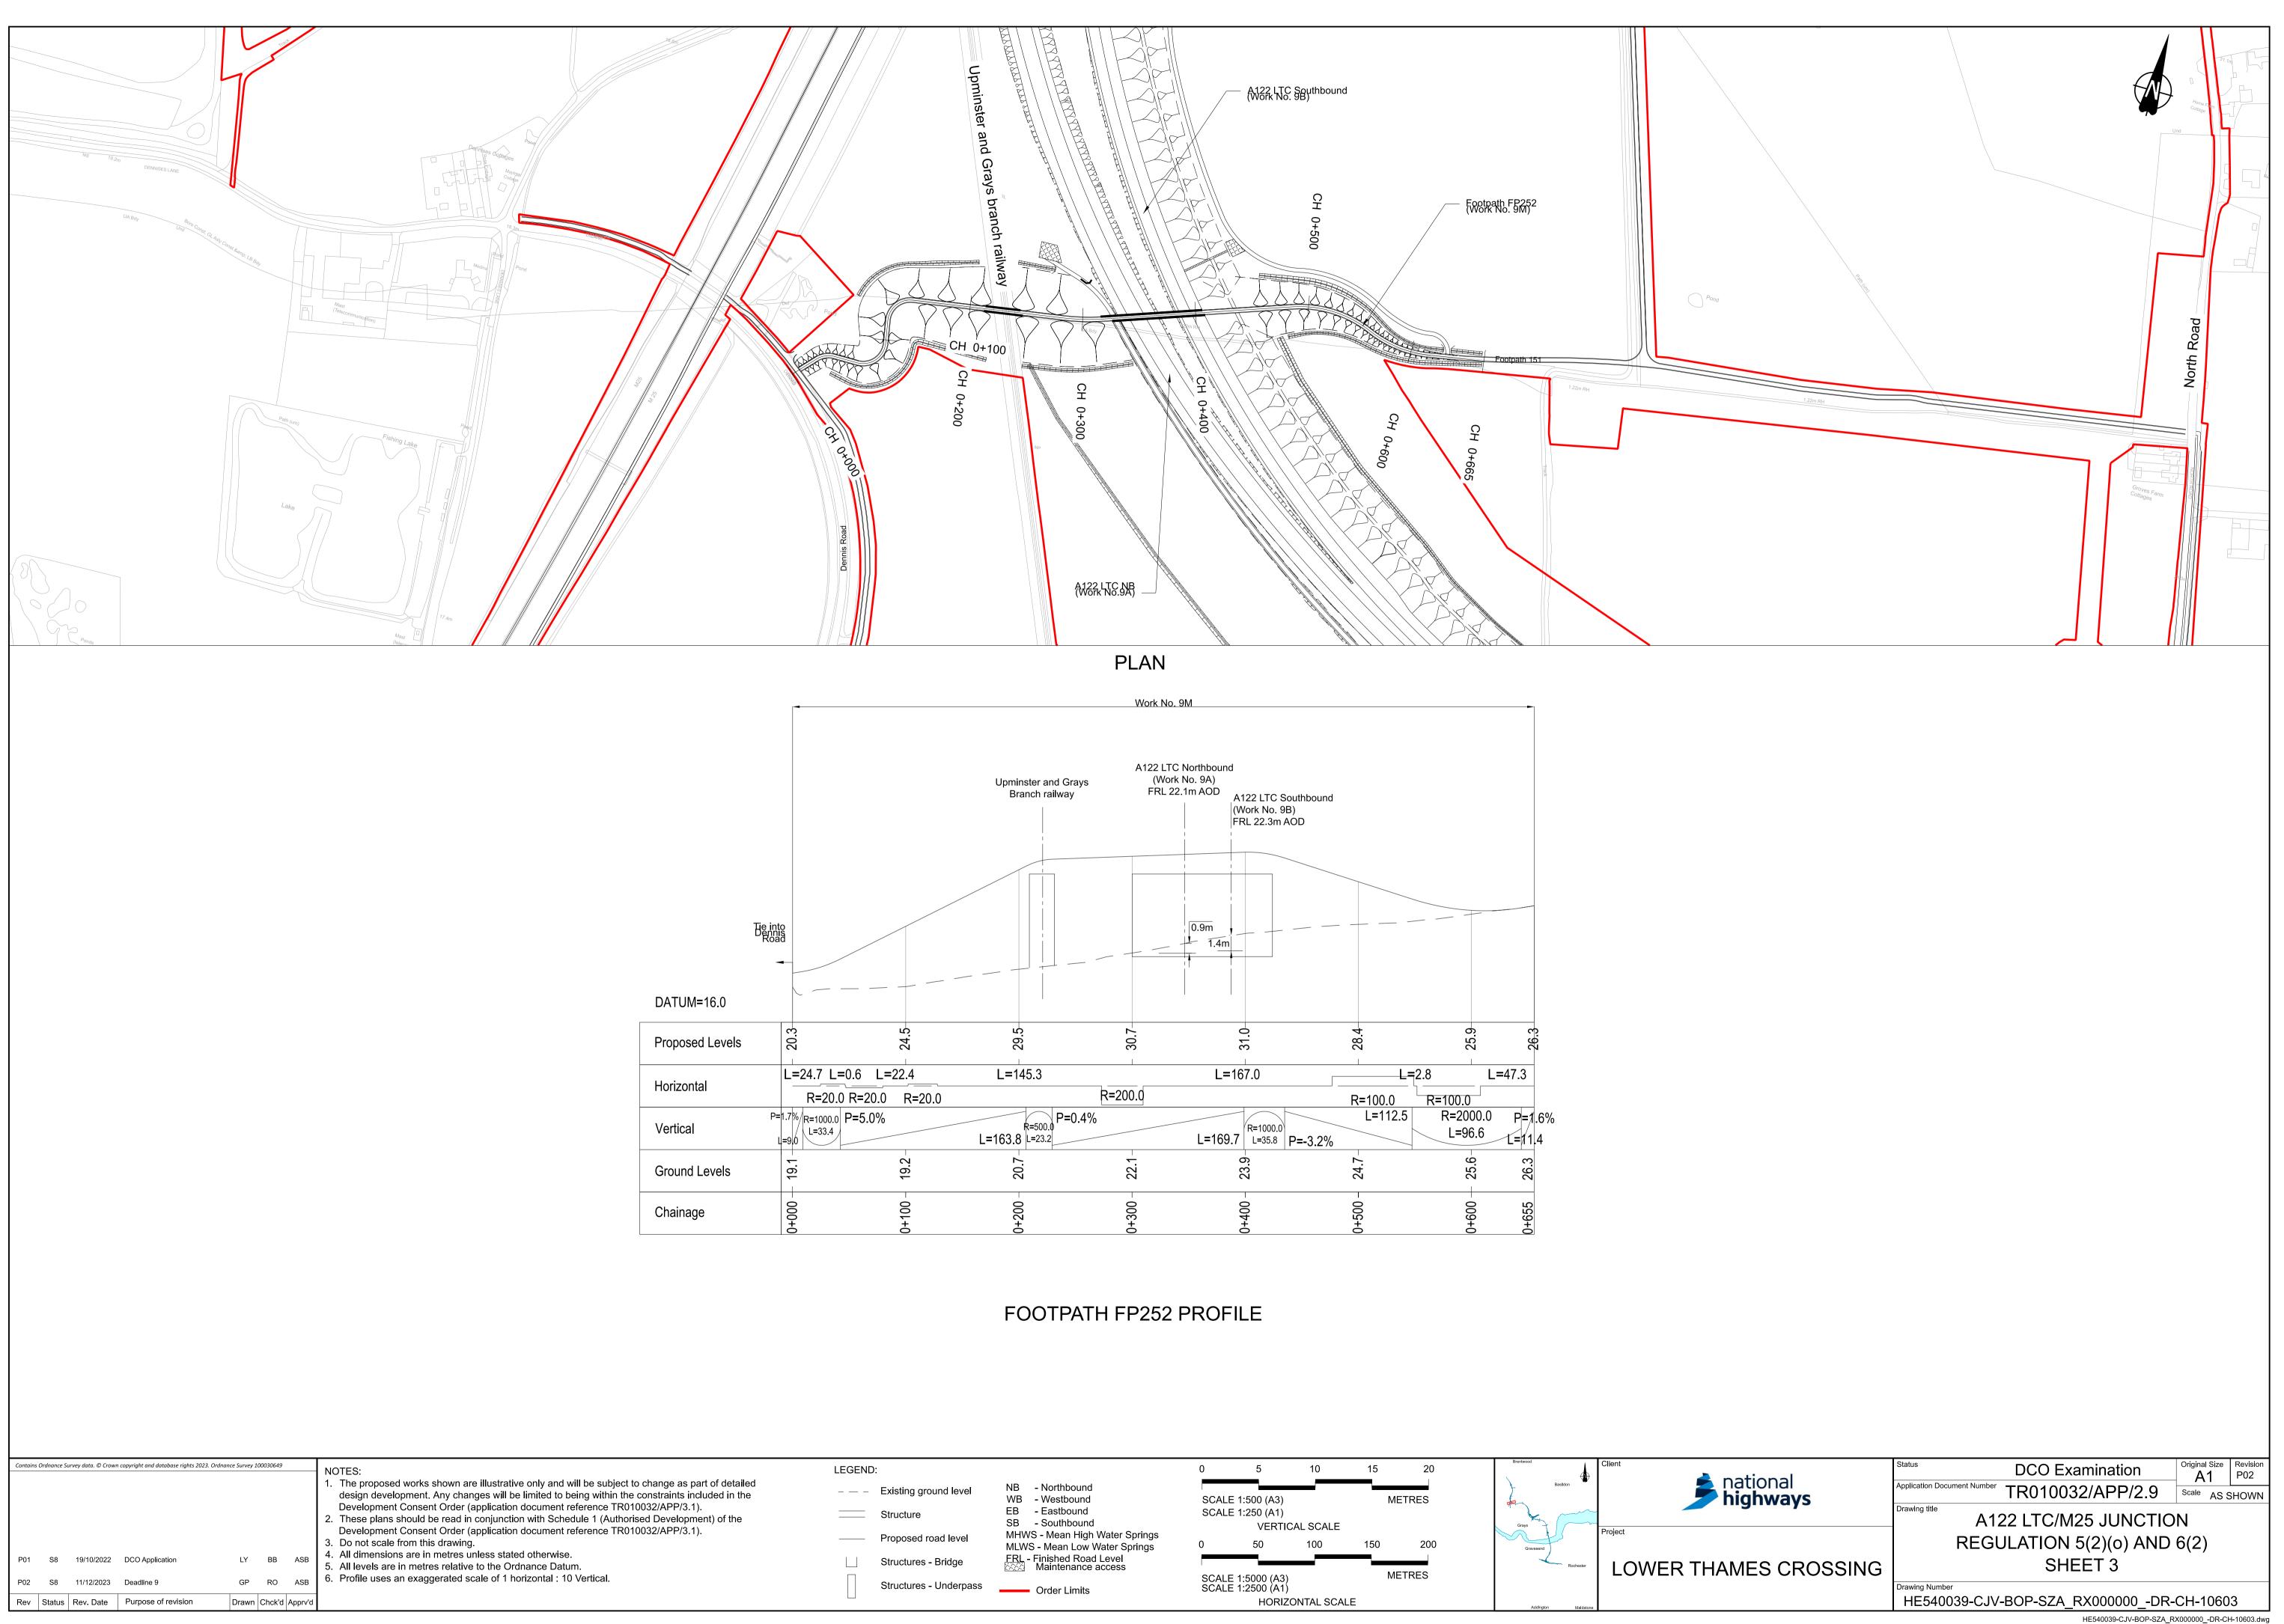

			5.	All levels are in metres relative to the Ordnance Dat
GP	RO	ASB	6.	Profile uses an exaggerated scale of 1 horizontal : 1

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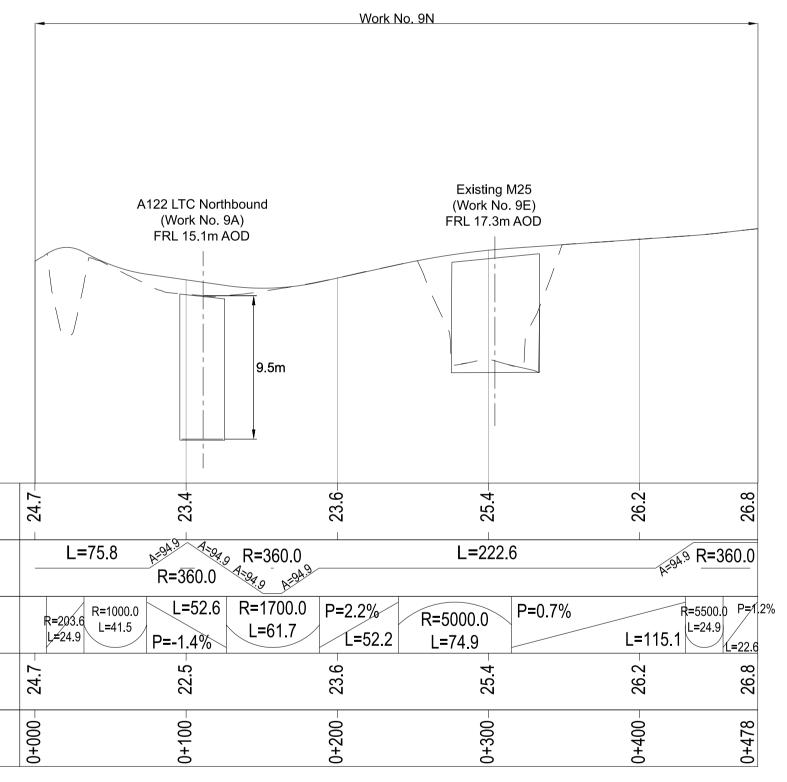
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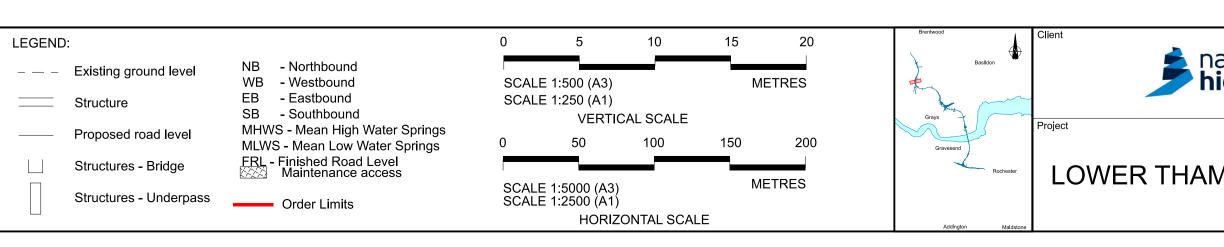
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Chainage

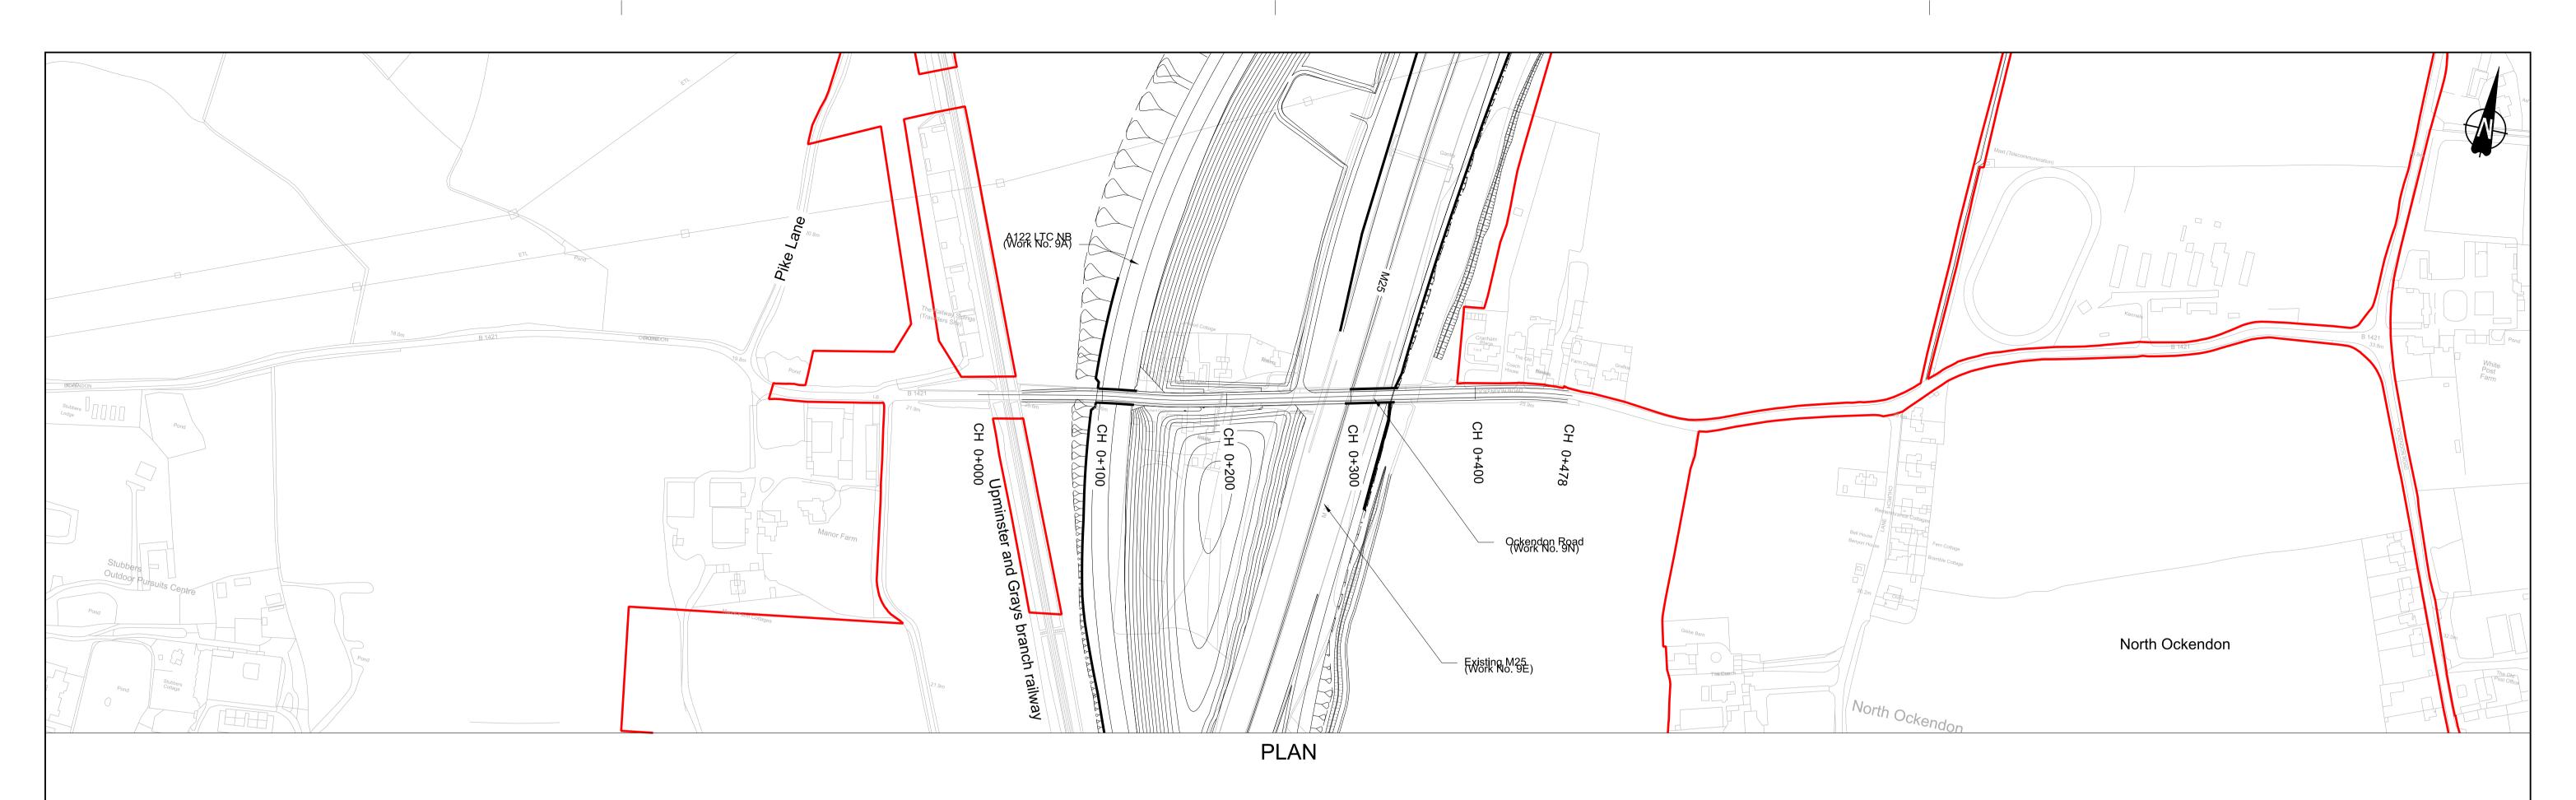
Contains	Ordnance Su	ırvey data. © Crown	copyright and database rights 2023. Ordnar	nce Survey 1	00030649		
P01	S8	19/10/2022	DCO Application	LY	BB	ASB	<ol> <li>NOTES:</li> <li>The proposed works shown are illustrative only and will be subject to change as part of detailed design development. Any changes will be limited to being within the constraints included in the Development Consent Order (application document reference TR010032/APP/3.1).</li> <li>These plans should be read in conjunction with Schedule 1 (Authorised Development) of the Development Consent Order (application document reference TR010032/APP/3.1).</li> <li>Do not scale from this drawing.</li> <li>All dimensions are in metres unless stated otherwise.</li> <li>All levels are in metres relative to the Ordnance Datum.</li> </ol>
P02	S8	11/12/2023	Deadline 9	GP	RO	ASB	6. Profile uses an exaggerated scale of 1 horizontal : 10 Vertical.
Rev	Status	Rev. Date	Purpose of revision	Drawn	Chck'd	Apprv'd	




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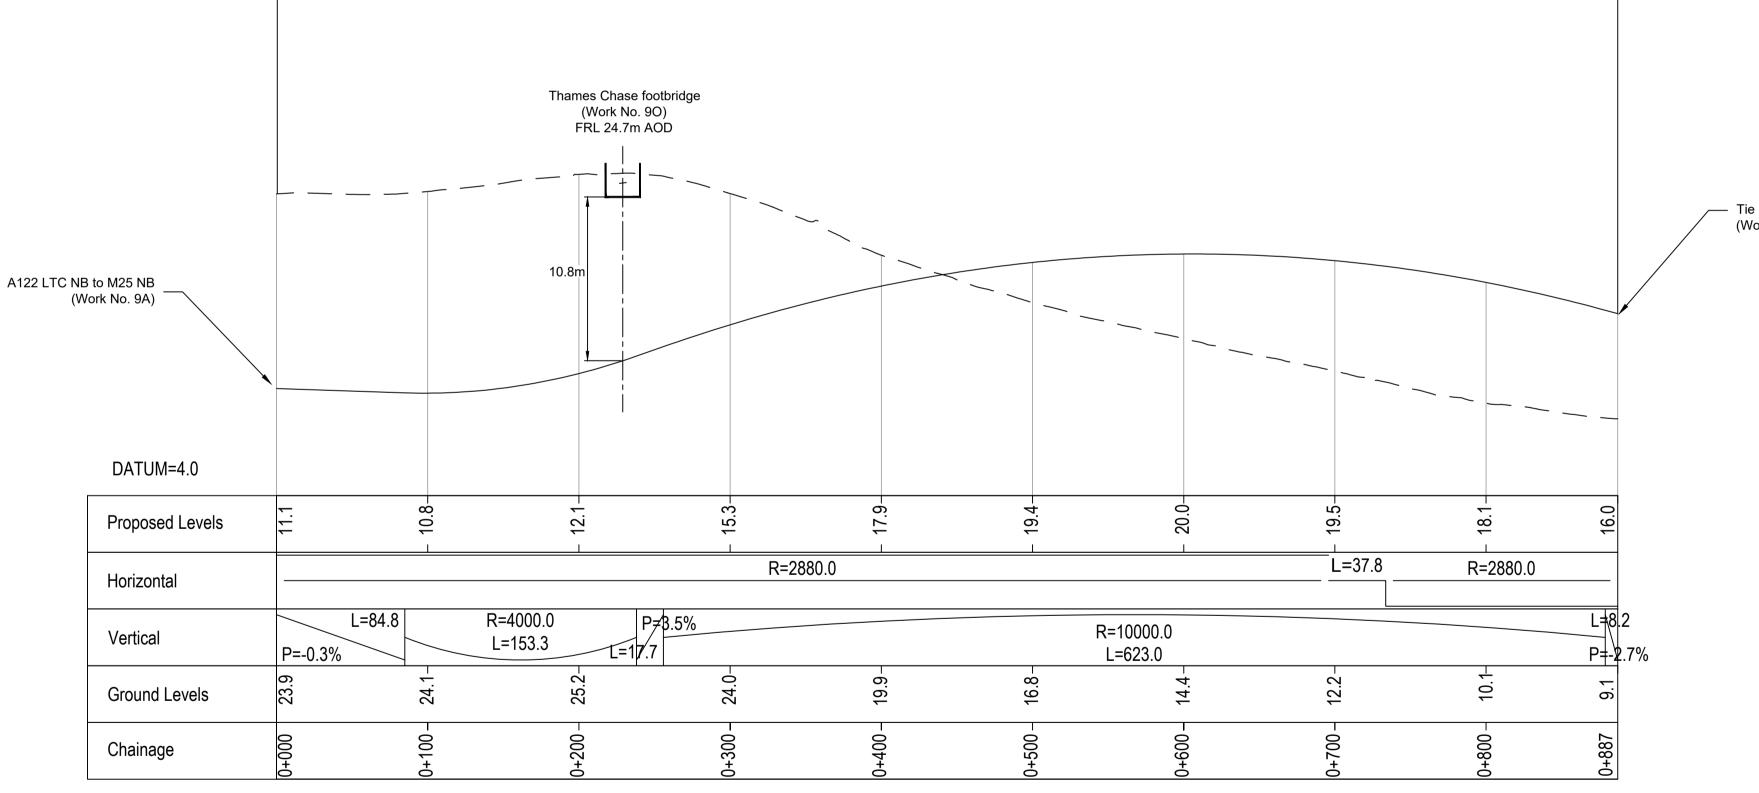


ational	Status DCO Examination	Original Size <b>A1</b>	Revision P02				
ational <b>ighways</b>	Application Document Number TR010032/APP/2.9		SHOWN				
iginiayo	Drawing title A122 LTC/M25 JUNCTION						
	REGULATION 5(2)(o) AND	6(2)					
MES CROSSING	SHEET 4						
	Drawing Number HE540039-CJV-BOP-SZA_RX000000DR-	CH-1060	4				
	HE540039-CJV-BOP-SZA_R	X000000DR-CH	l-10604.dwg				

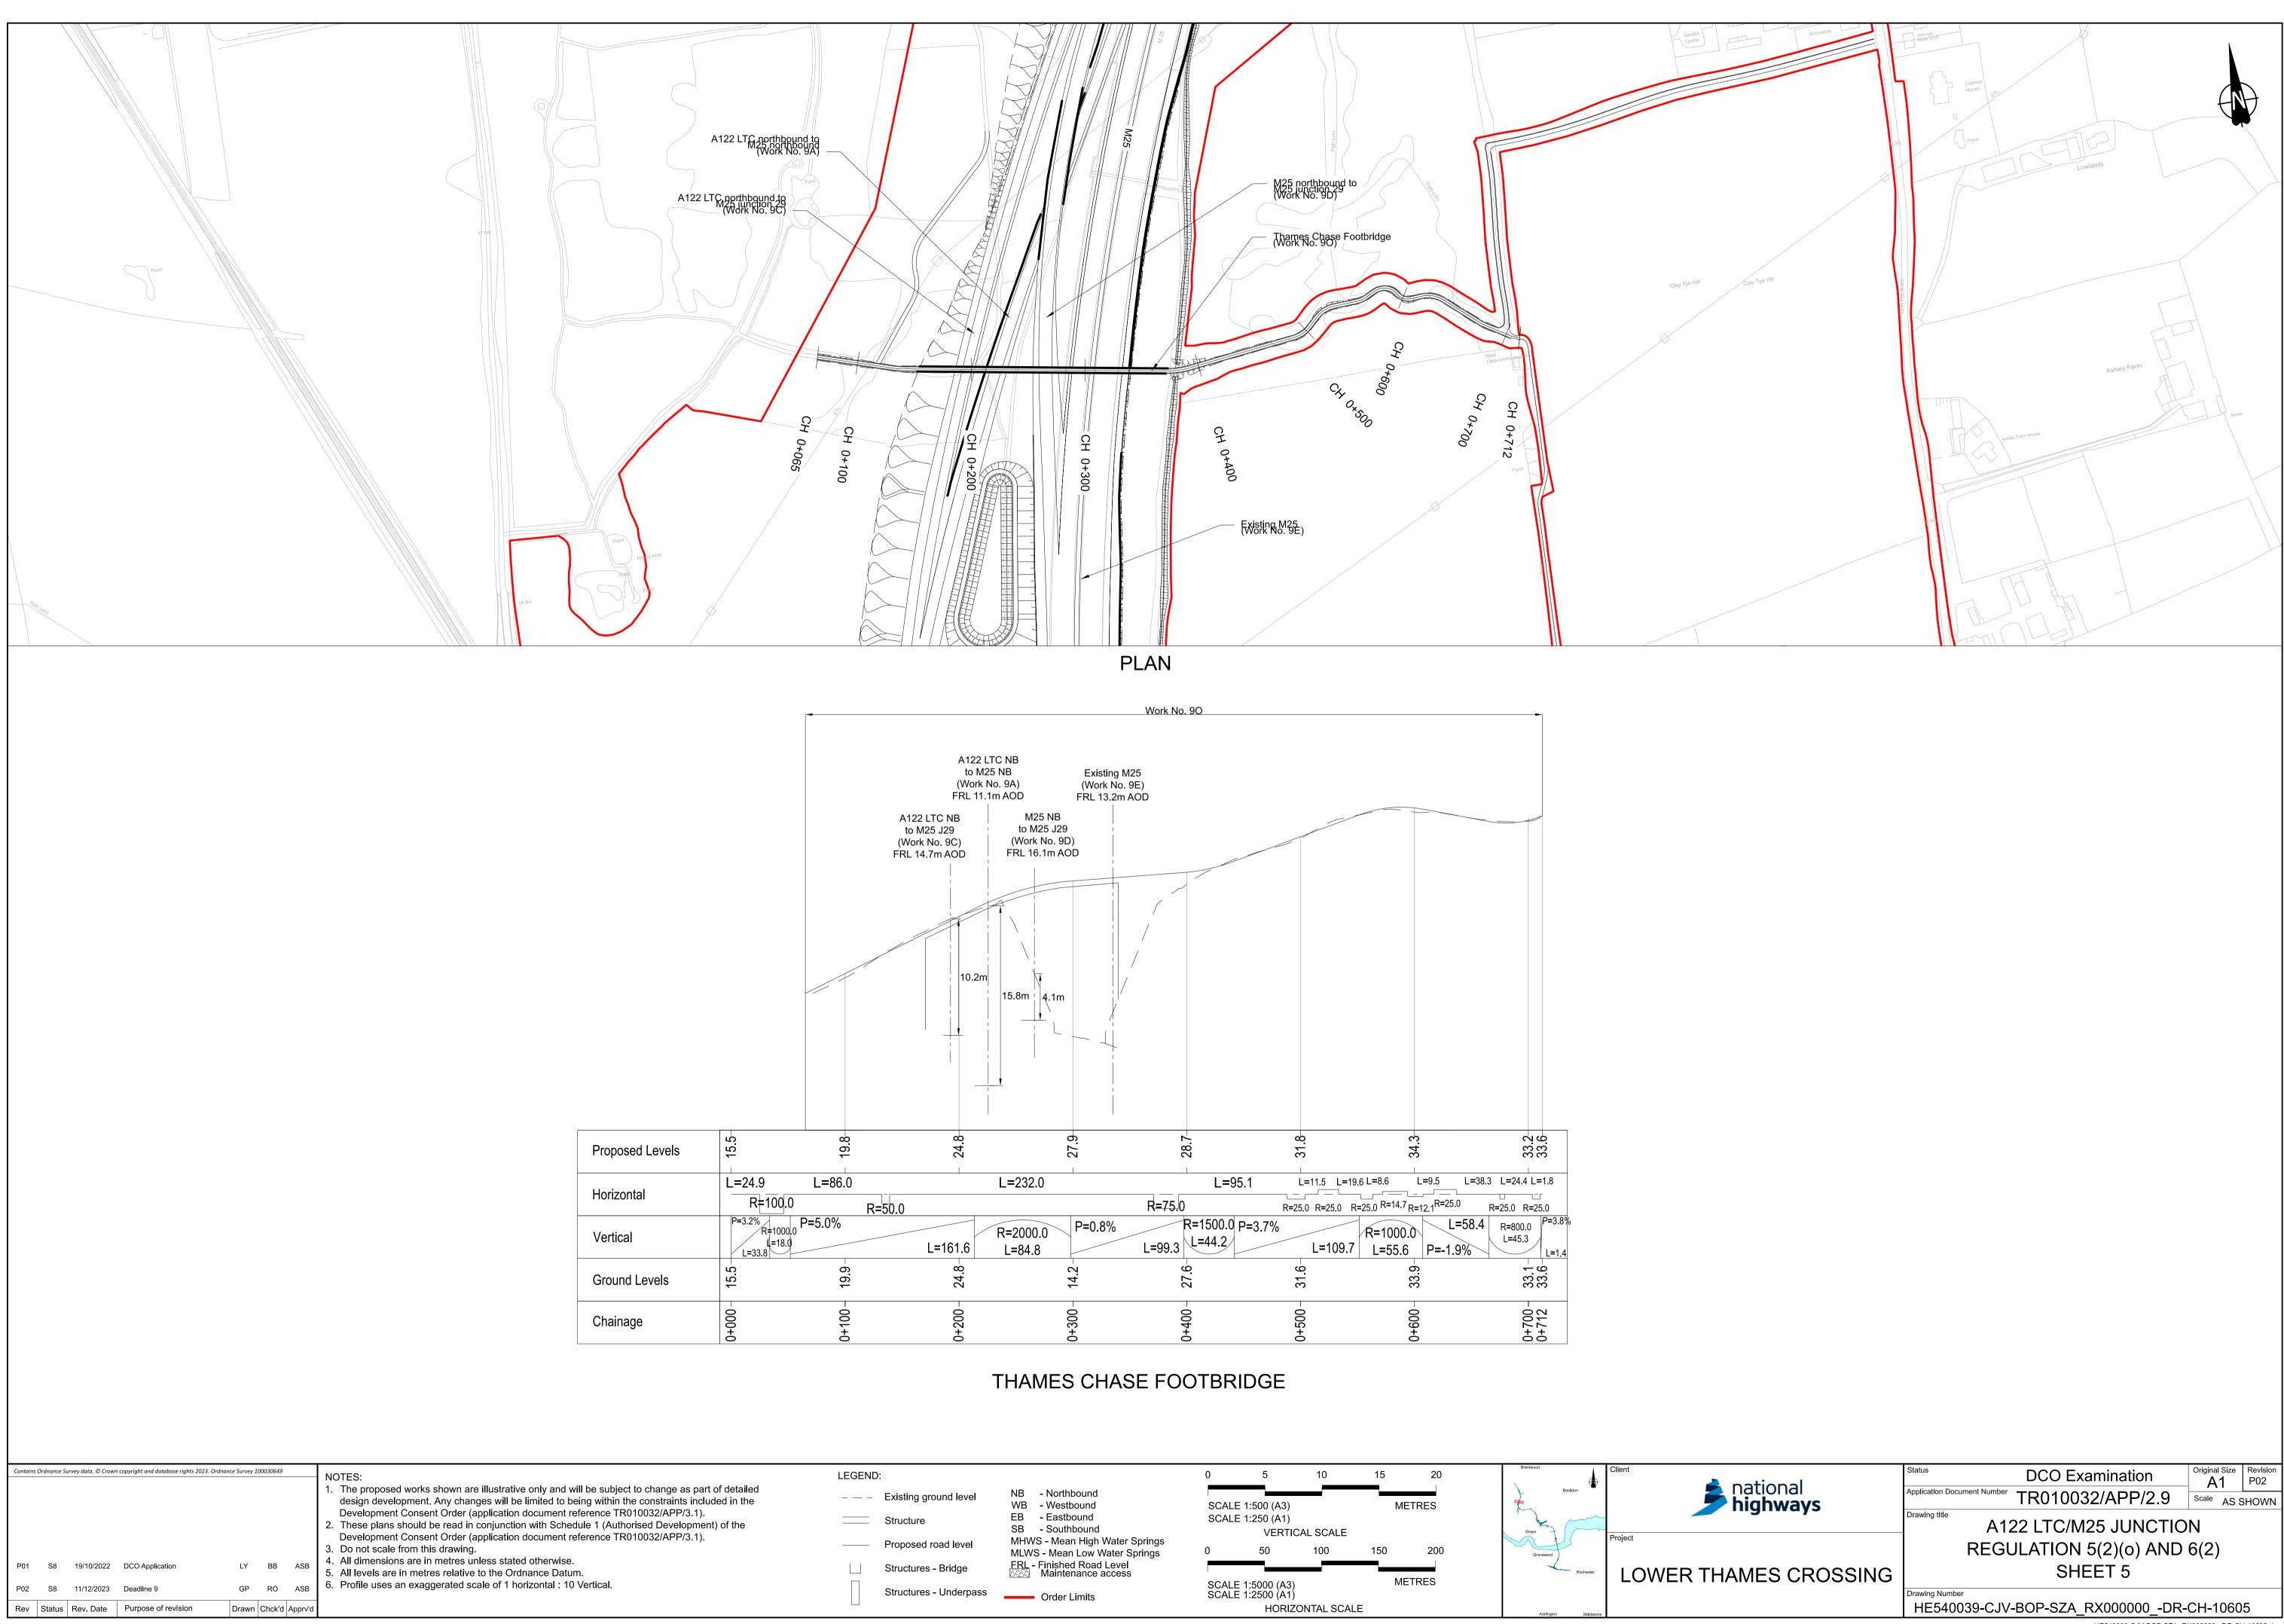

ational	Status DCO Examination	Original Size	Revision P02			
ational <b>ighways</b>	Application Document Number TR010032/APP/2.9		HOWN			
·9····a,5	Drawing title A122 LTC/M25 JUNCTIO	N				
	REGULATION 5(2)(0) AND	6(2)				
MES CROSSING	SHEET 5					
	Drawing Number HE540039-CJV-BOP-SZA_RX000000DR-0	CH-1060	5			




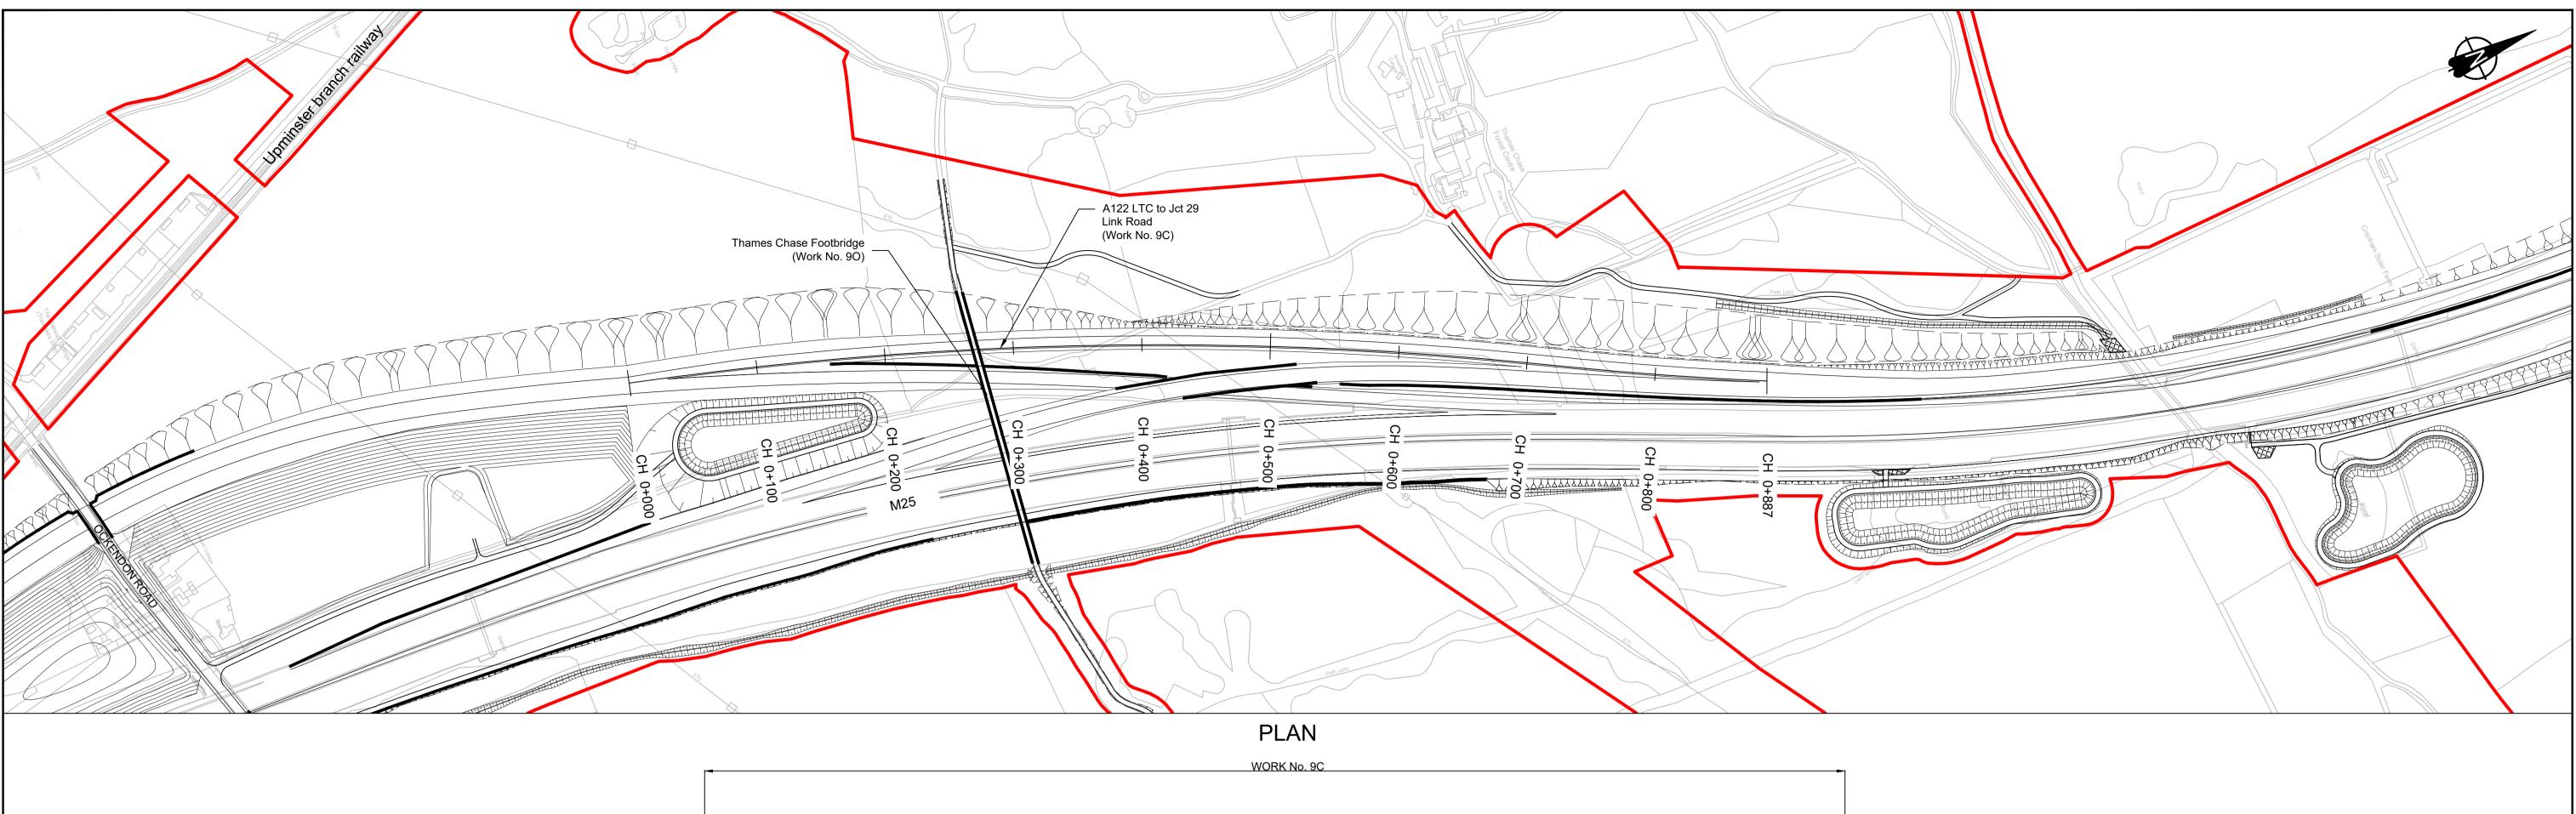

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P01	S8	19/10/2022	DCO Application	LY	BB	ASB	<ol> <li>All dimensions are in metres unless stated otherwise.</li> <li>All levels are in metres relative to the Ordnance Datum.</li> </ol>
P02	S8	11/12/2023	Deadline 9	GP	RO	ASB	6. Profile uses an exaggerated scale of 1 horizontal : 10 Vertical.
Rev	Status	Rev. Date	Purpose of revision	Drawn	Chck'd	Apprv'd	


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# A122 LTC NORTHBOUND TO M25 JUNCTION 29 PROFILE

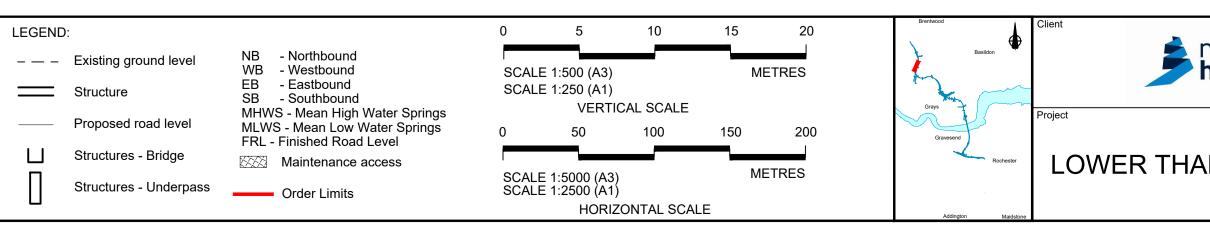

— Tie into M25 Junction 29 (Work No. 9D)

antional	Status DCO Examination	Original Size	Revision P02			
national <b>highways</b>	Application Document Number TR010032/APP/2.9	Scale AS S	HOWN			
ing.intayo	Drawing title A122 LTC/M25 JUNCTION					
	REGULATION 5(2)(0) AND 6(2)					
MES CROSSING	SHEET 6					
	Drawing Number HE540039-CJV-BOP-SZA_RX000000DR-	CH-1060	6			
	HE540039-CJV-BOP-SZA_R	K000000DR-CH	l-10606.dwg			

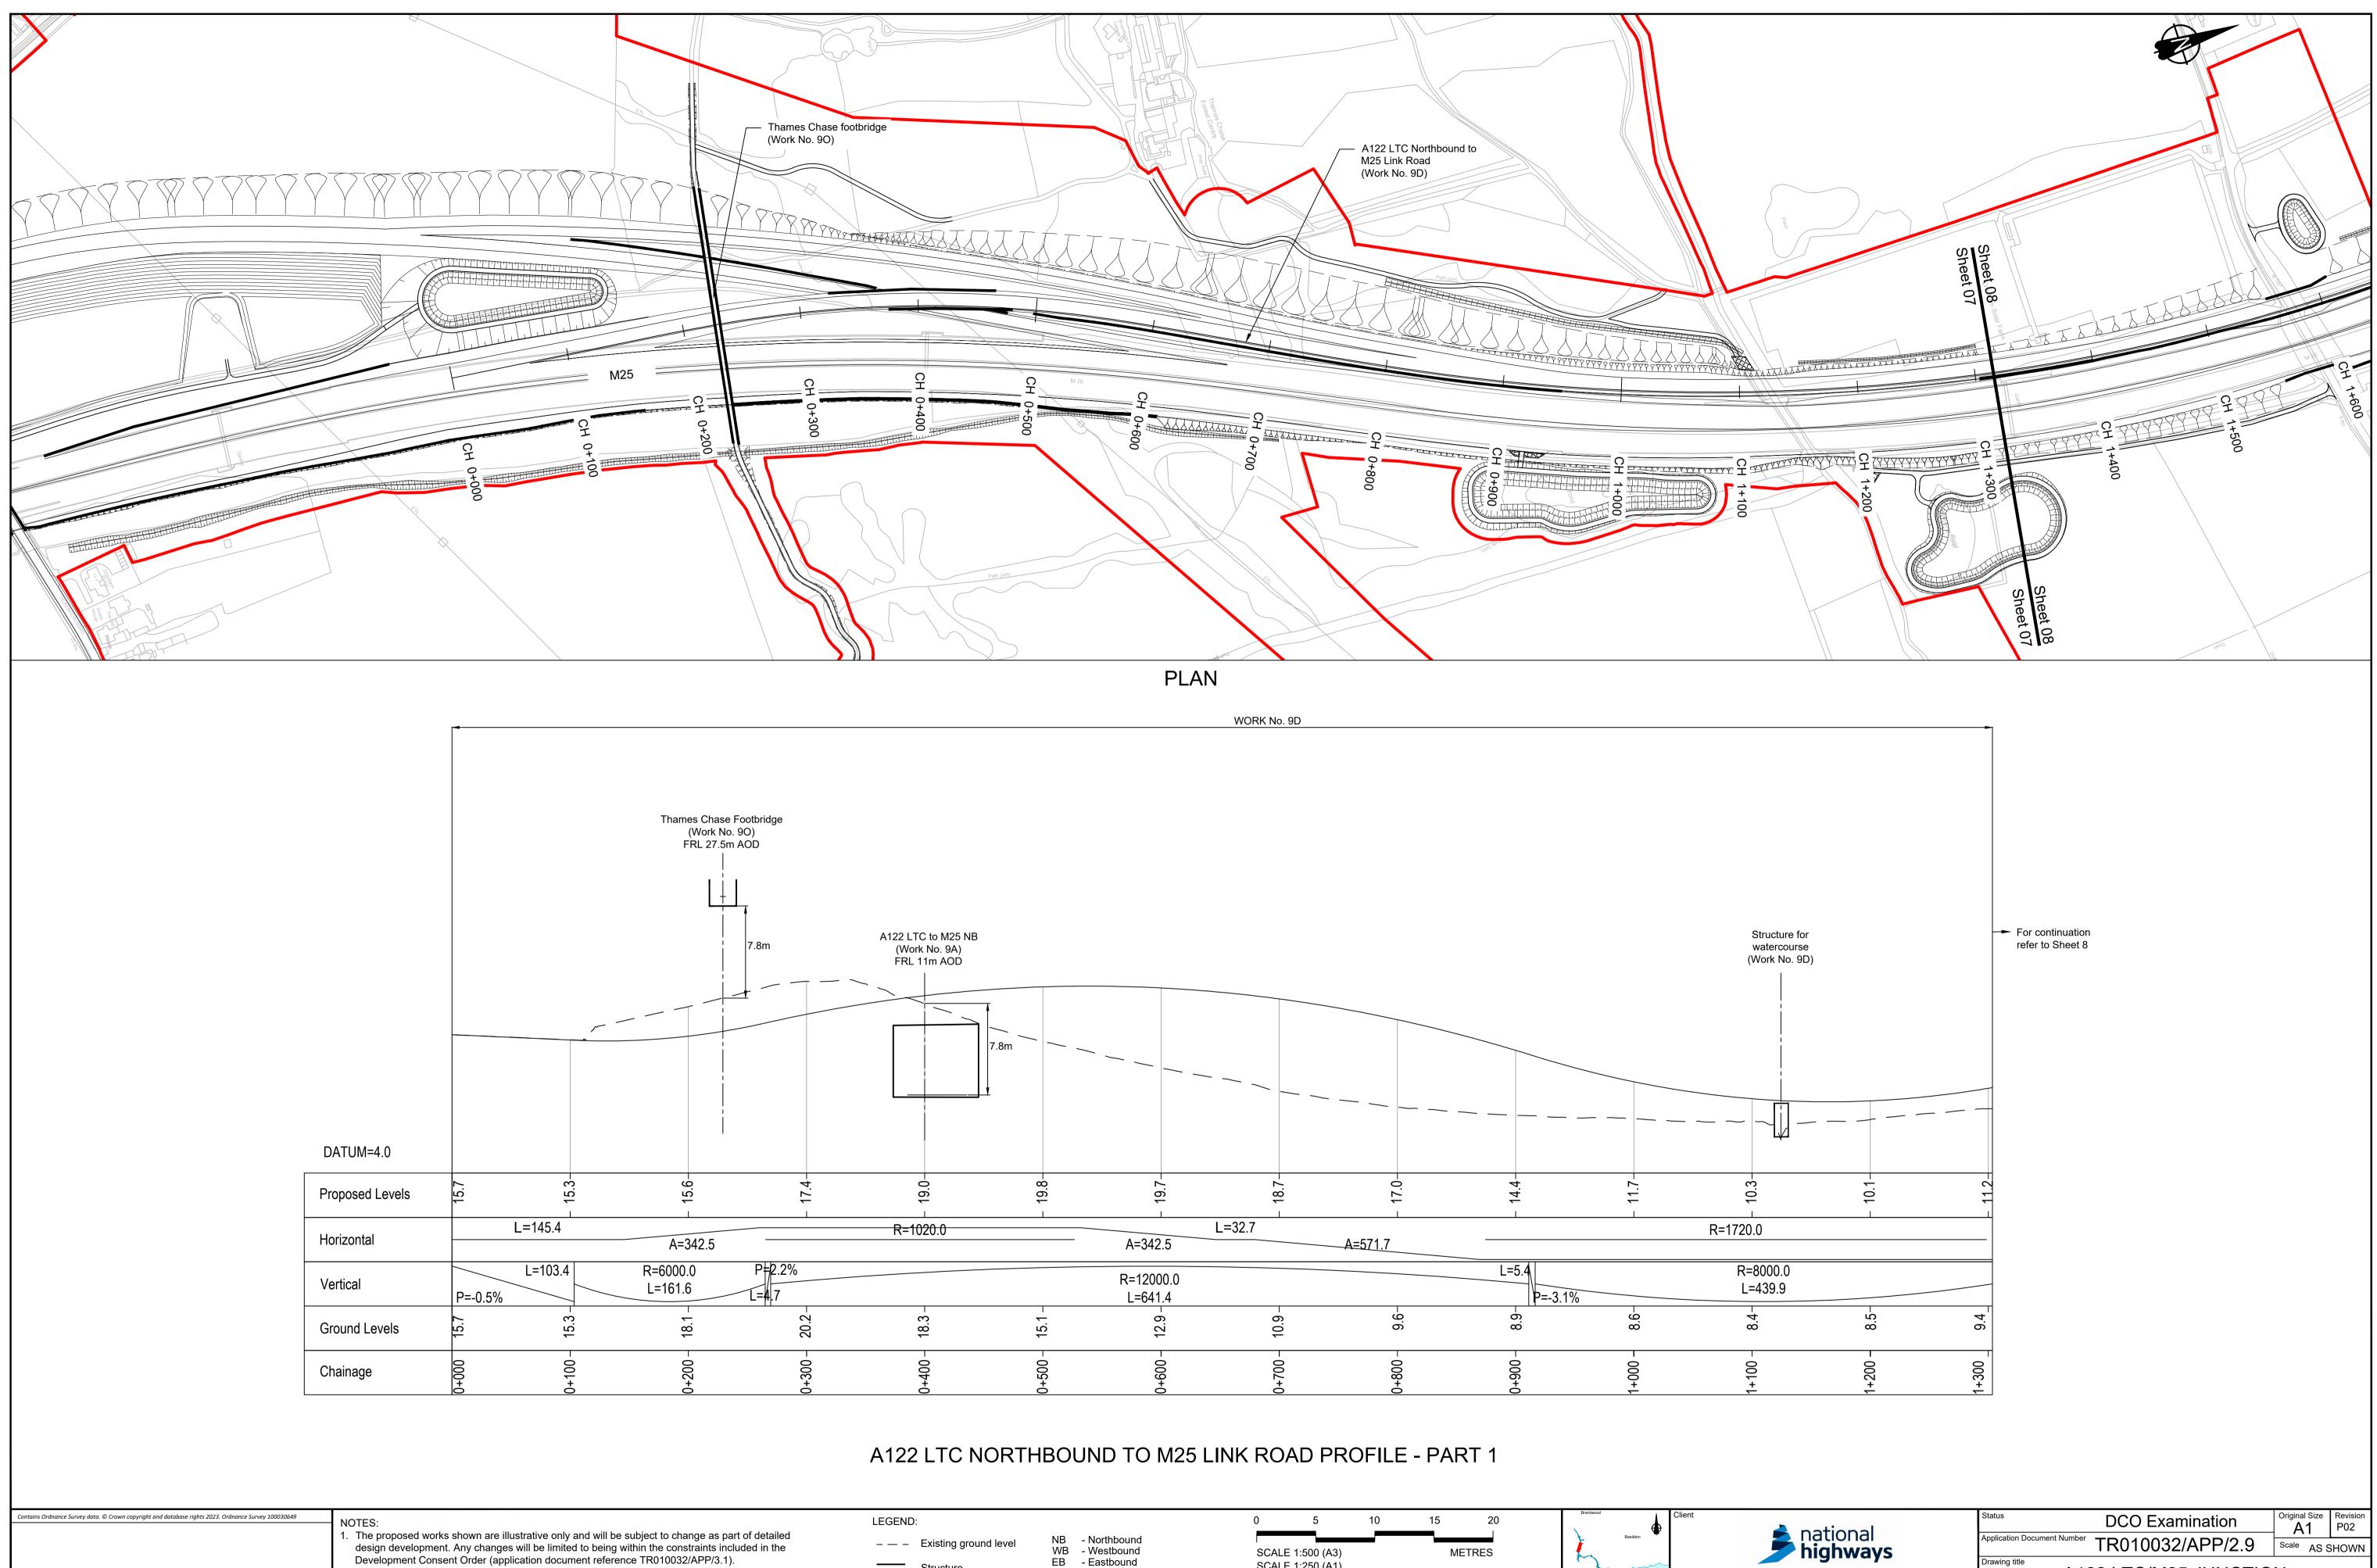

2. These plans should be read in conjunction with Schedule 1 (Authorised Development) of the

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Development Consent Order (application document reference TR010032/APP/3.1).

3. Do not scale from this drawing. 4. All dimensions are in metres unless stated otherwise.

5. All levels are in metres relative to the Ordnance Datum.


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P02 S8 11/12/2023 Deadline 9 GP RO ASB Rev Status Rev. Date Purpose of revision


P01 S8 19/10/2022 DCO Application

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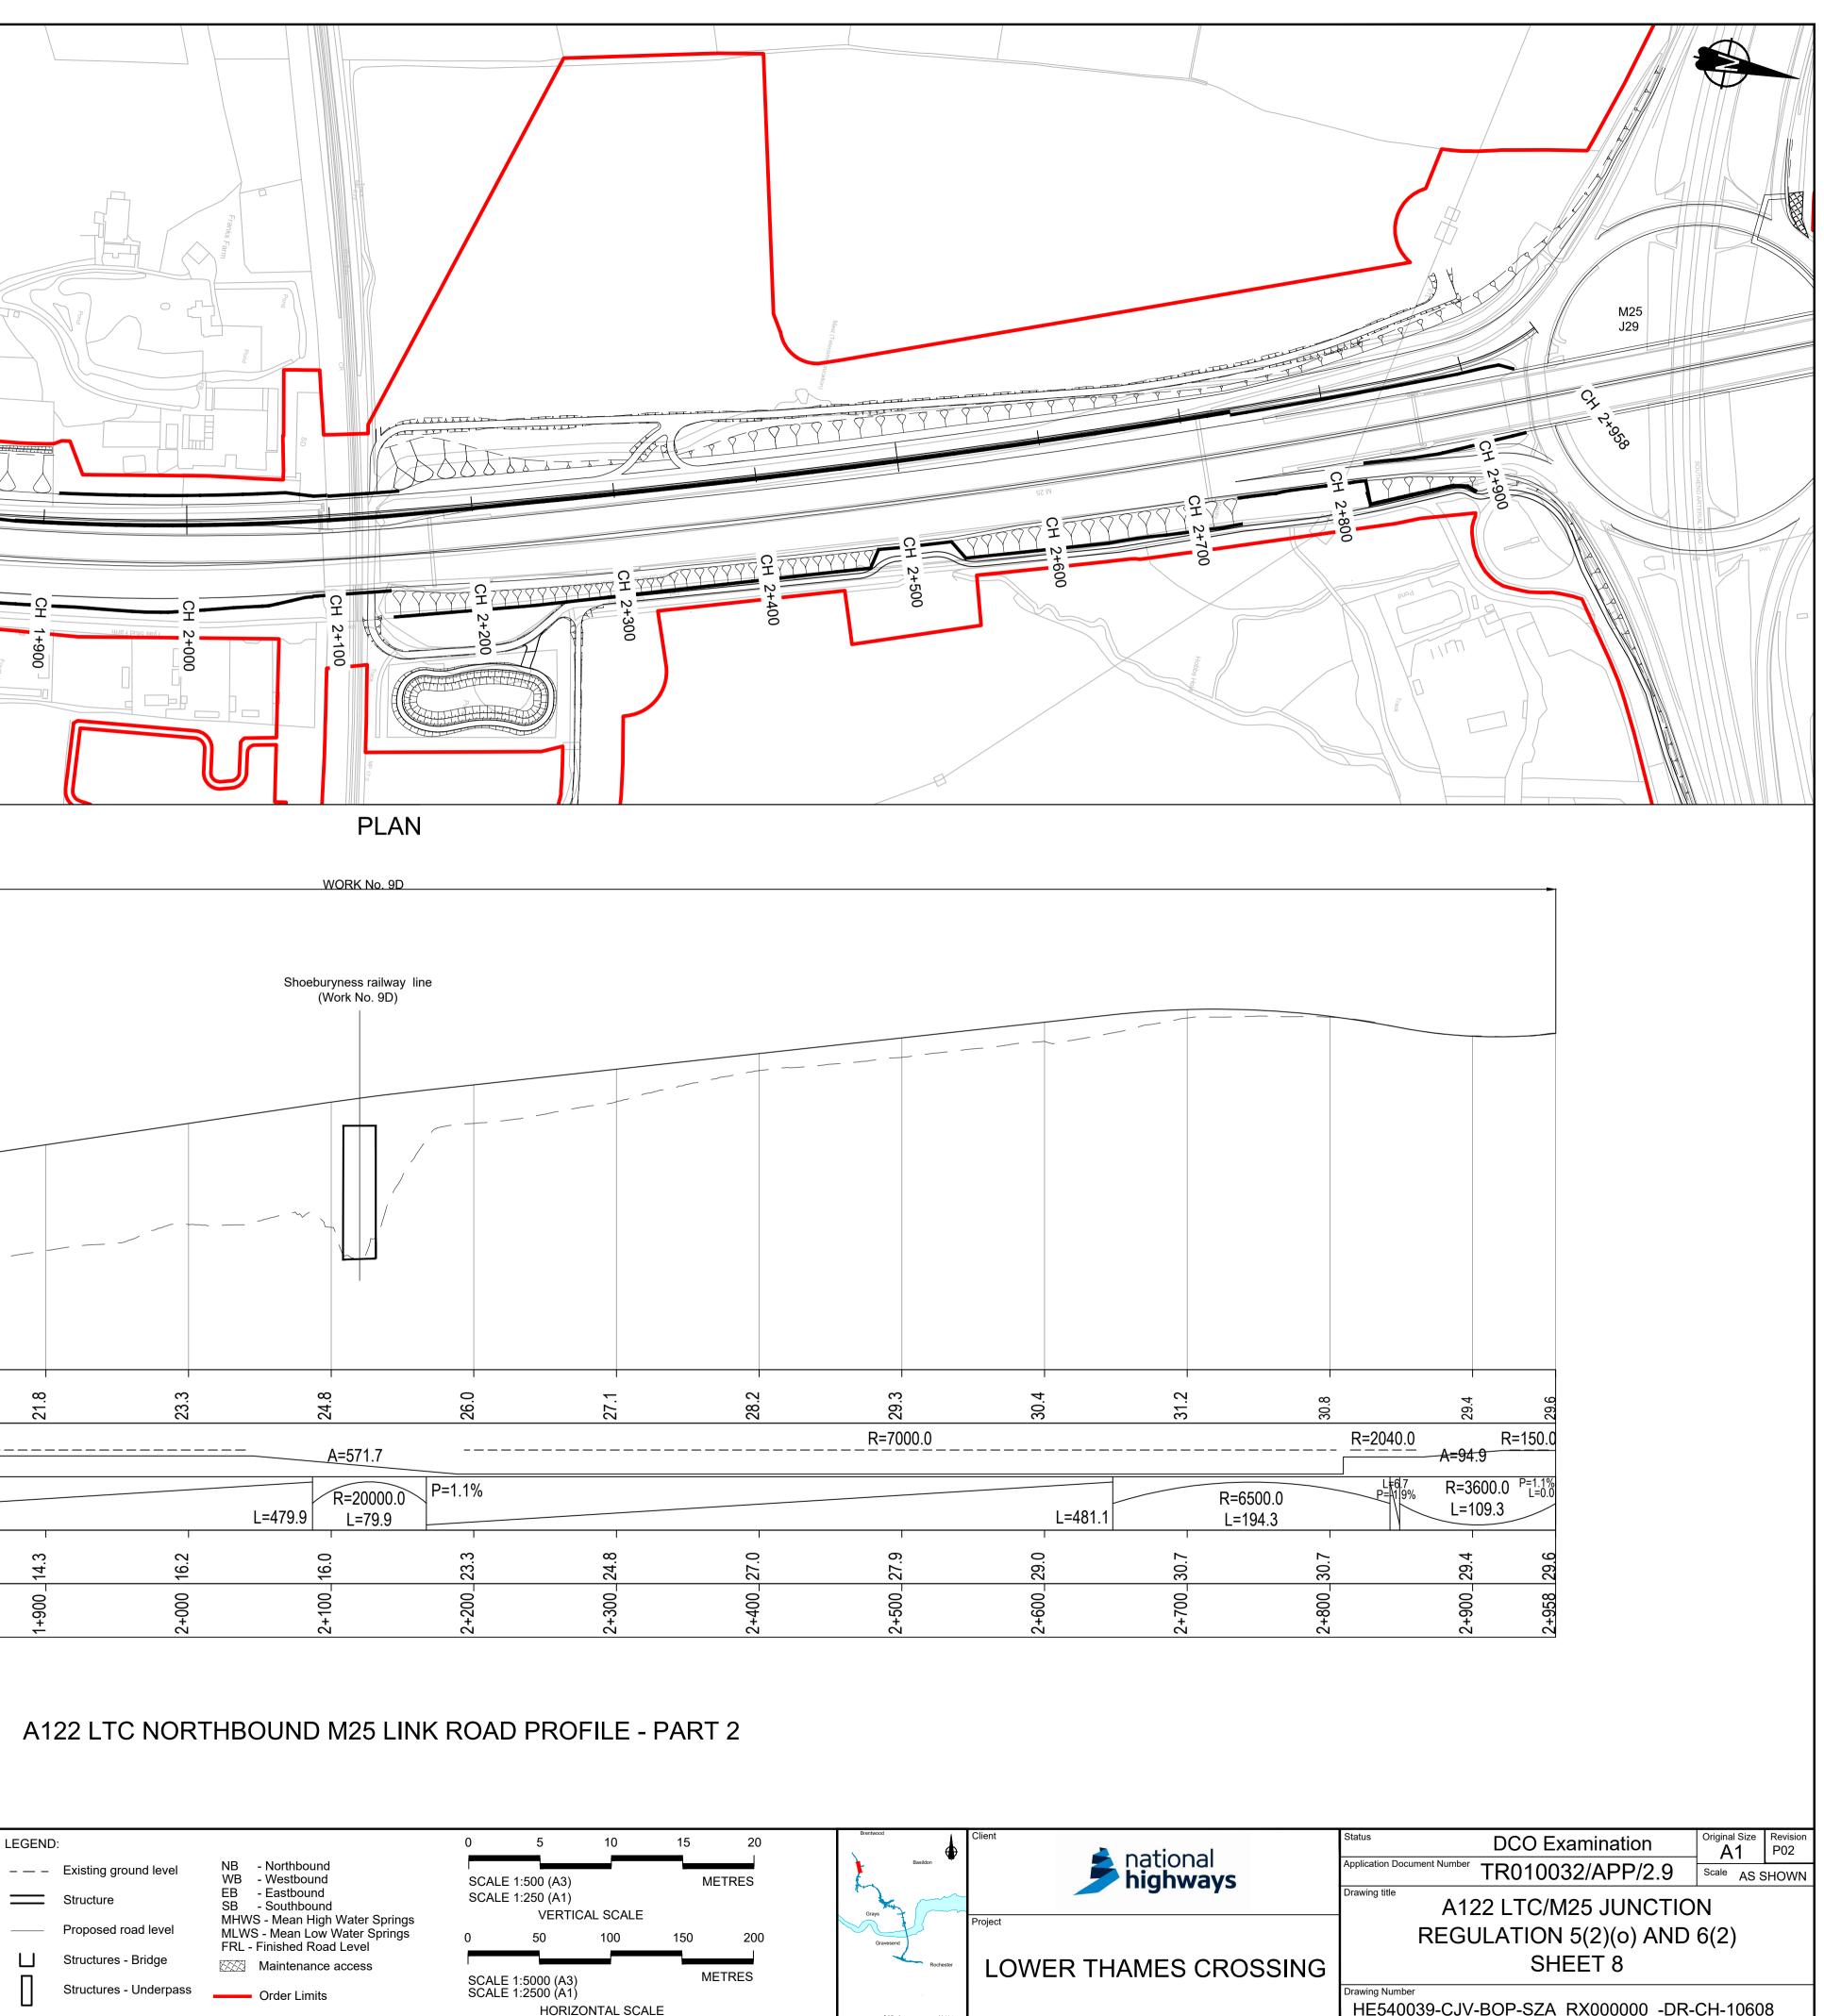



national	Status DCO Examination	Original Size Revision A1 P02				
highways	Application Document Number TR010032/APP/2.9	Scale AS SHOWN				
inginiays	Drawing title A122 LTC/M25 JUNCTIO	N				
	REGULATION 5(2)(0) AND 6(2)					
AMES CROSSING	SHEET 7					
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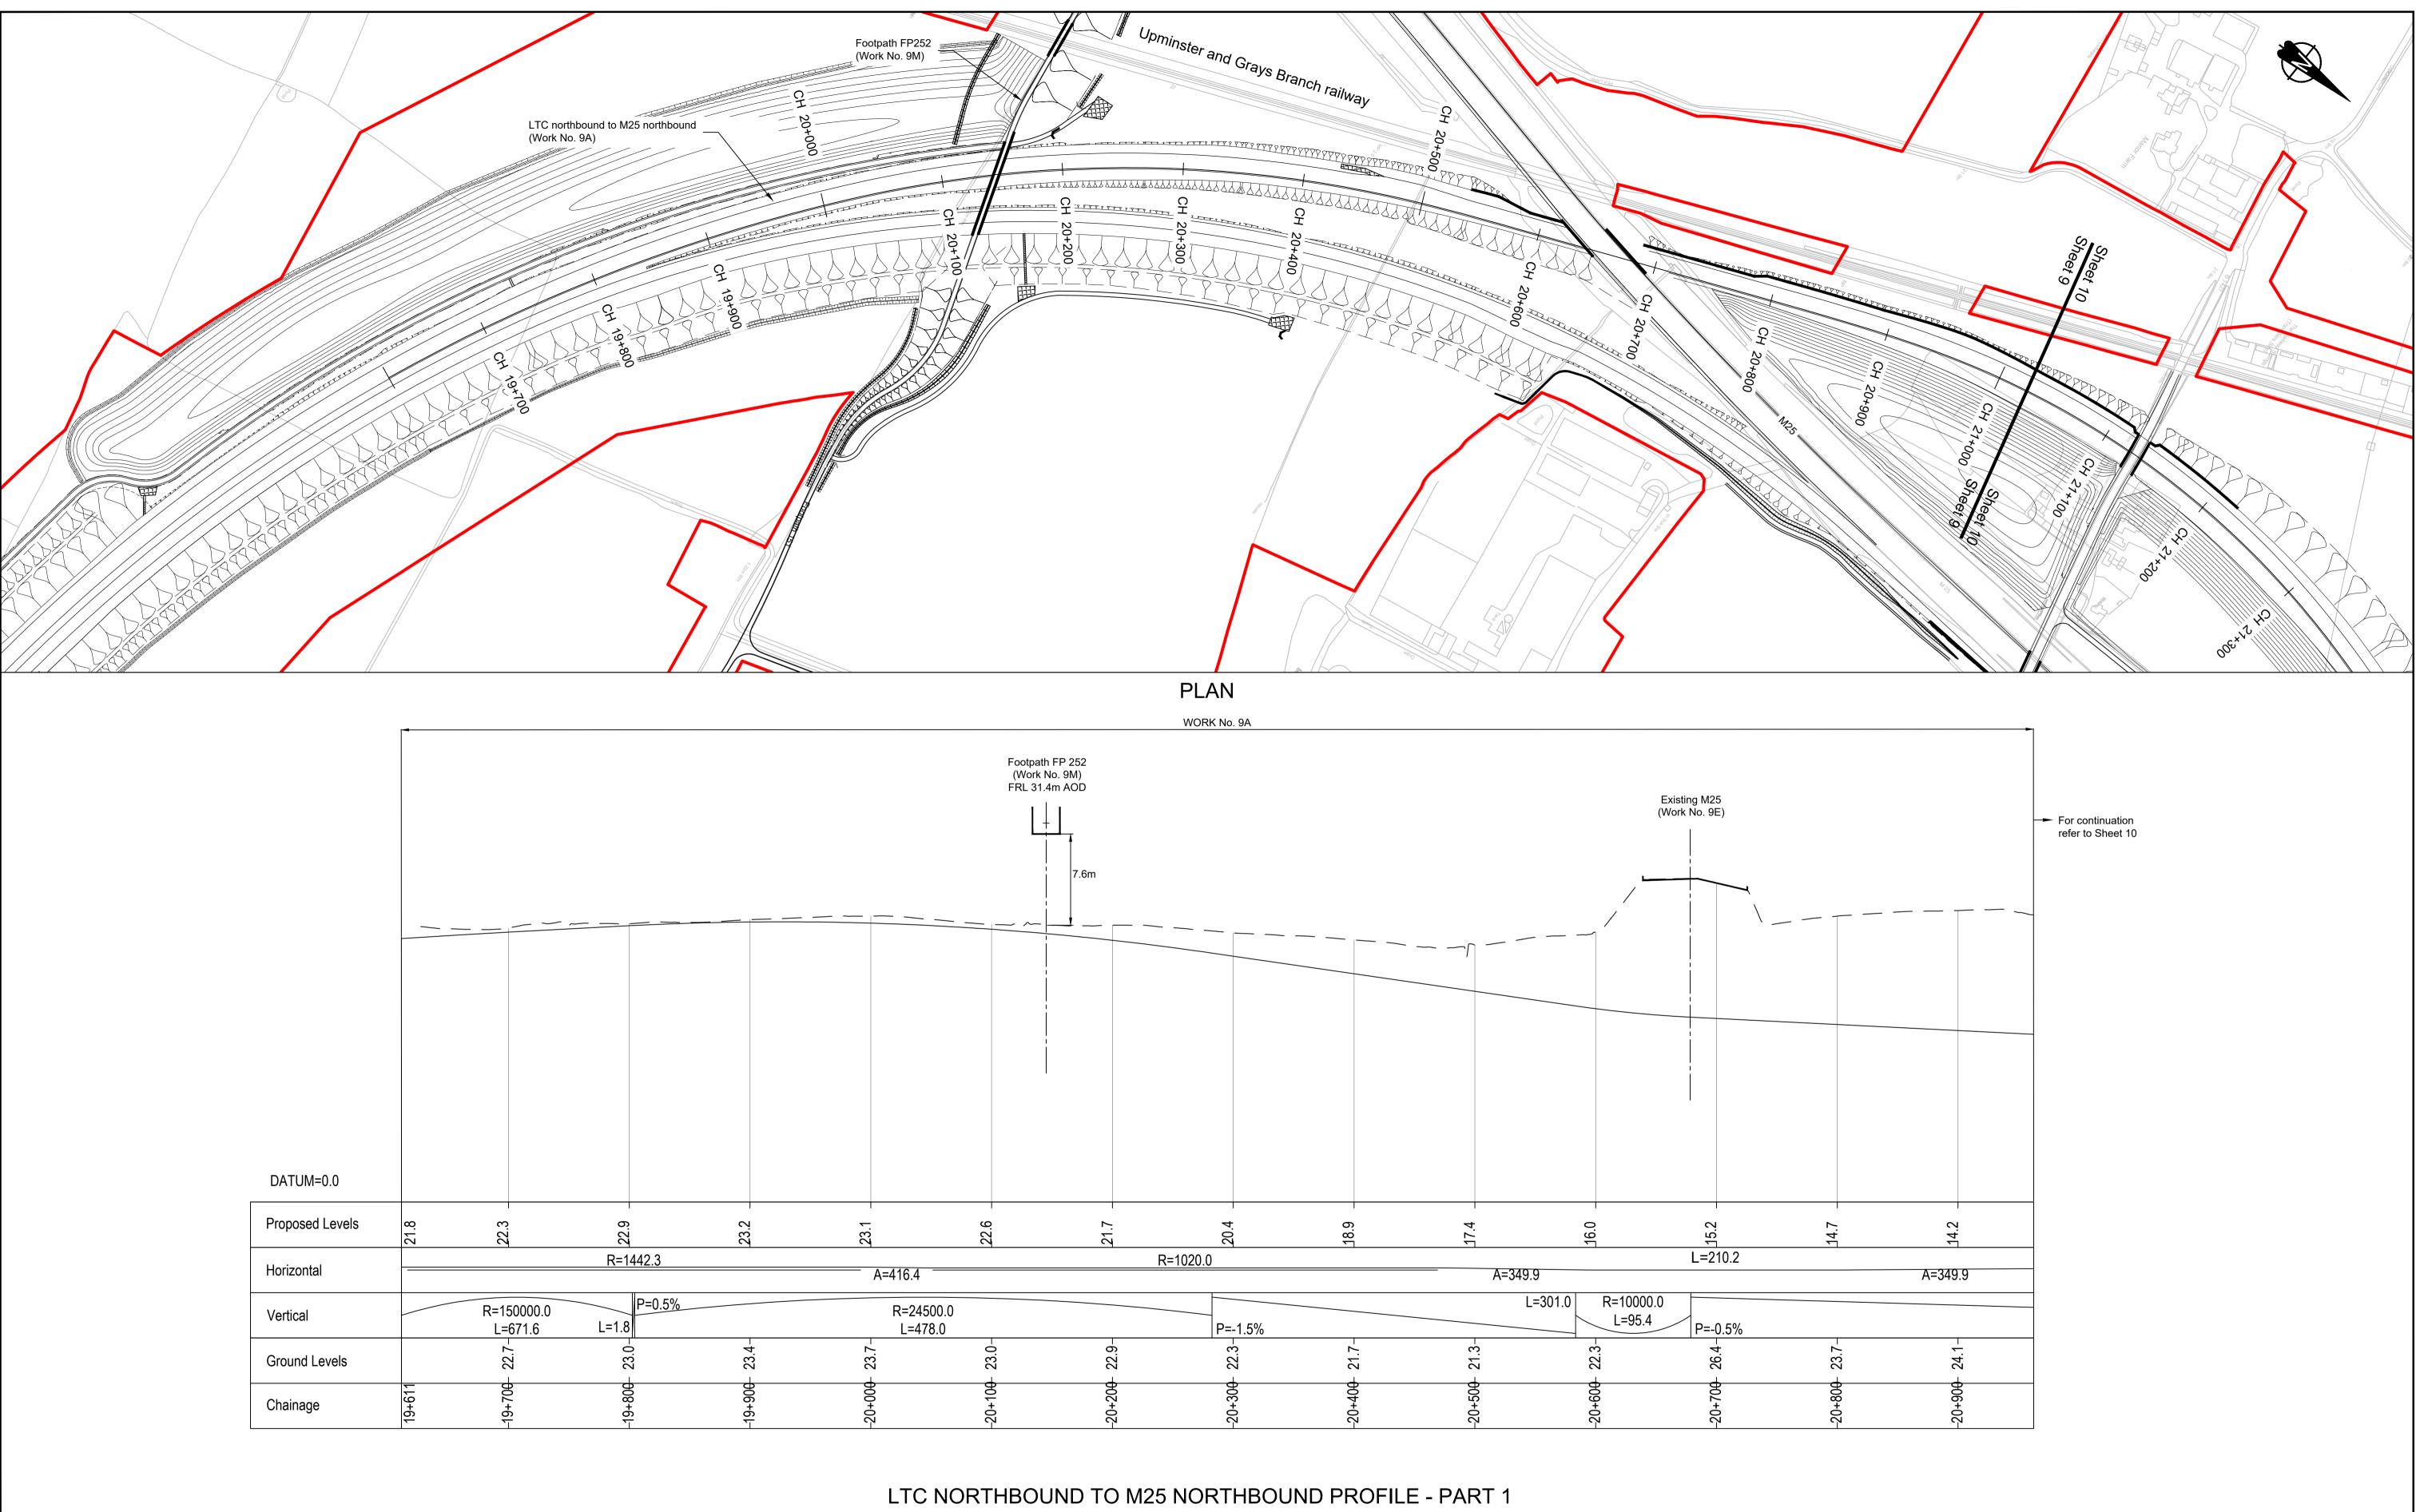


For continuation – refer to Sheet 7						
DATUM=6.0						
Proposed Levels	11.2	15 ວັ	17.3	18 8.00	20.3	
Horizontal				R=1720.0		
Vertical	R=8000.0 P=2.4% L=439.9 L=38.7	R=23 L=2		P=1.5%		
Ground Levels	9.5	12.4	10.8	11.7	13.7	
Chainage	1+304					
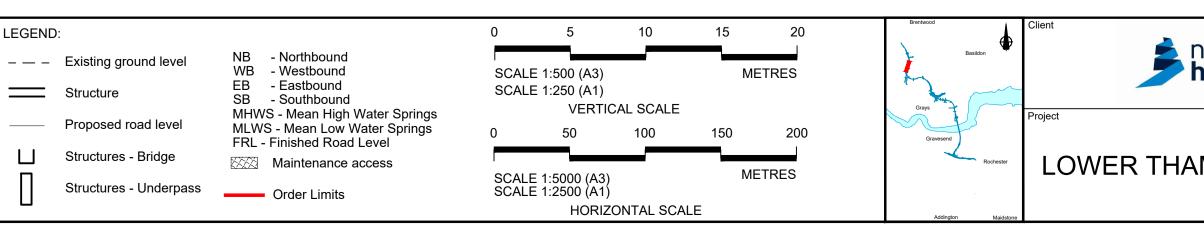
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Rev	Status	Rev. Date	Purpose of revision	Drawn	Chck'd	Apprv'd	

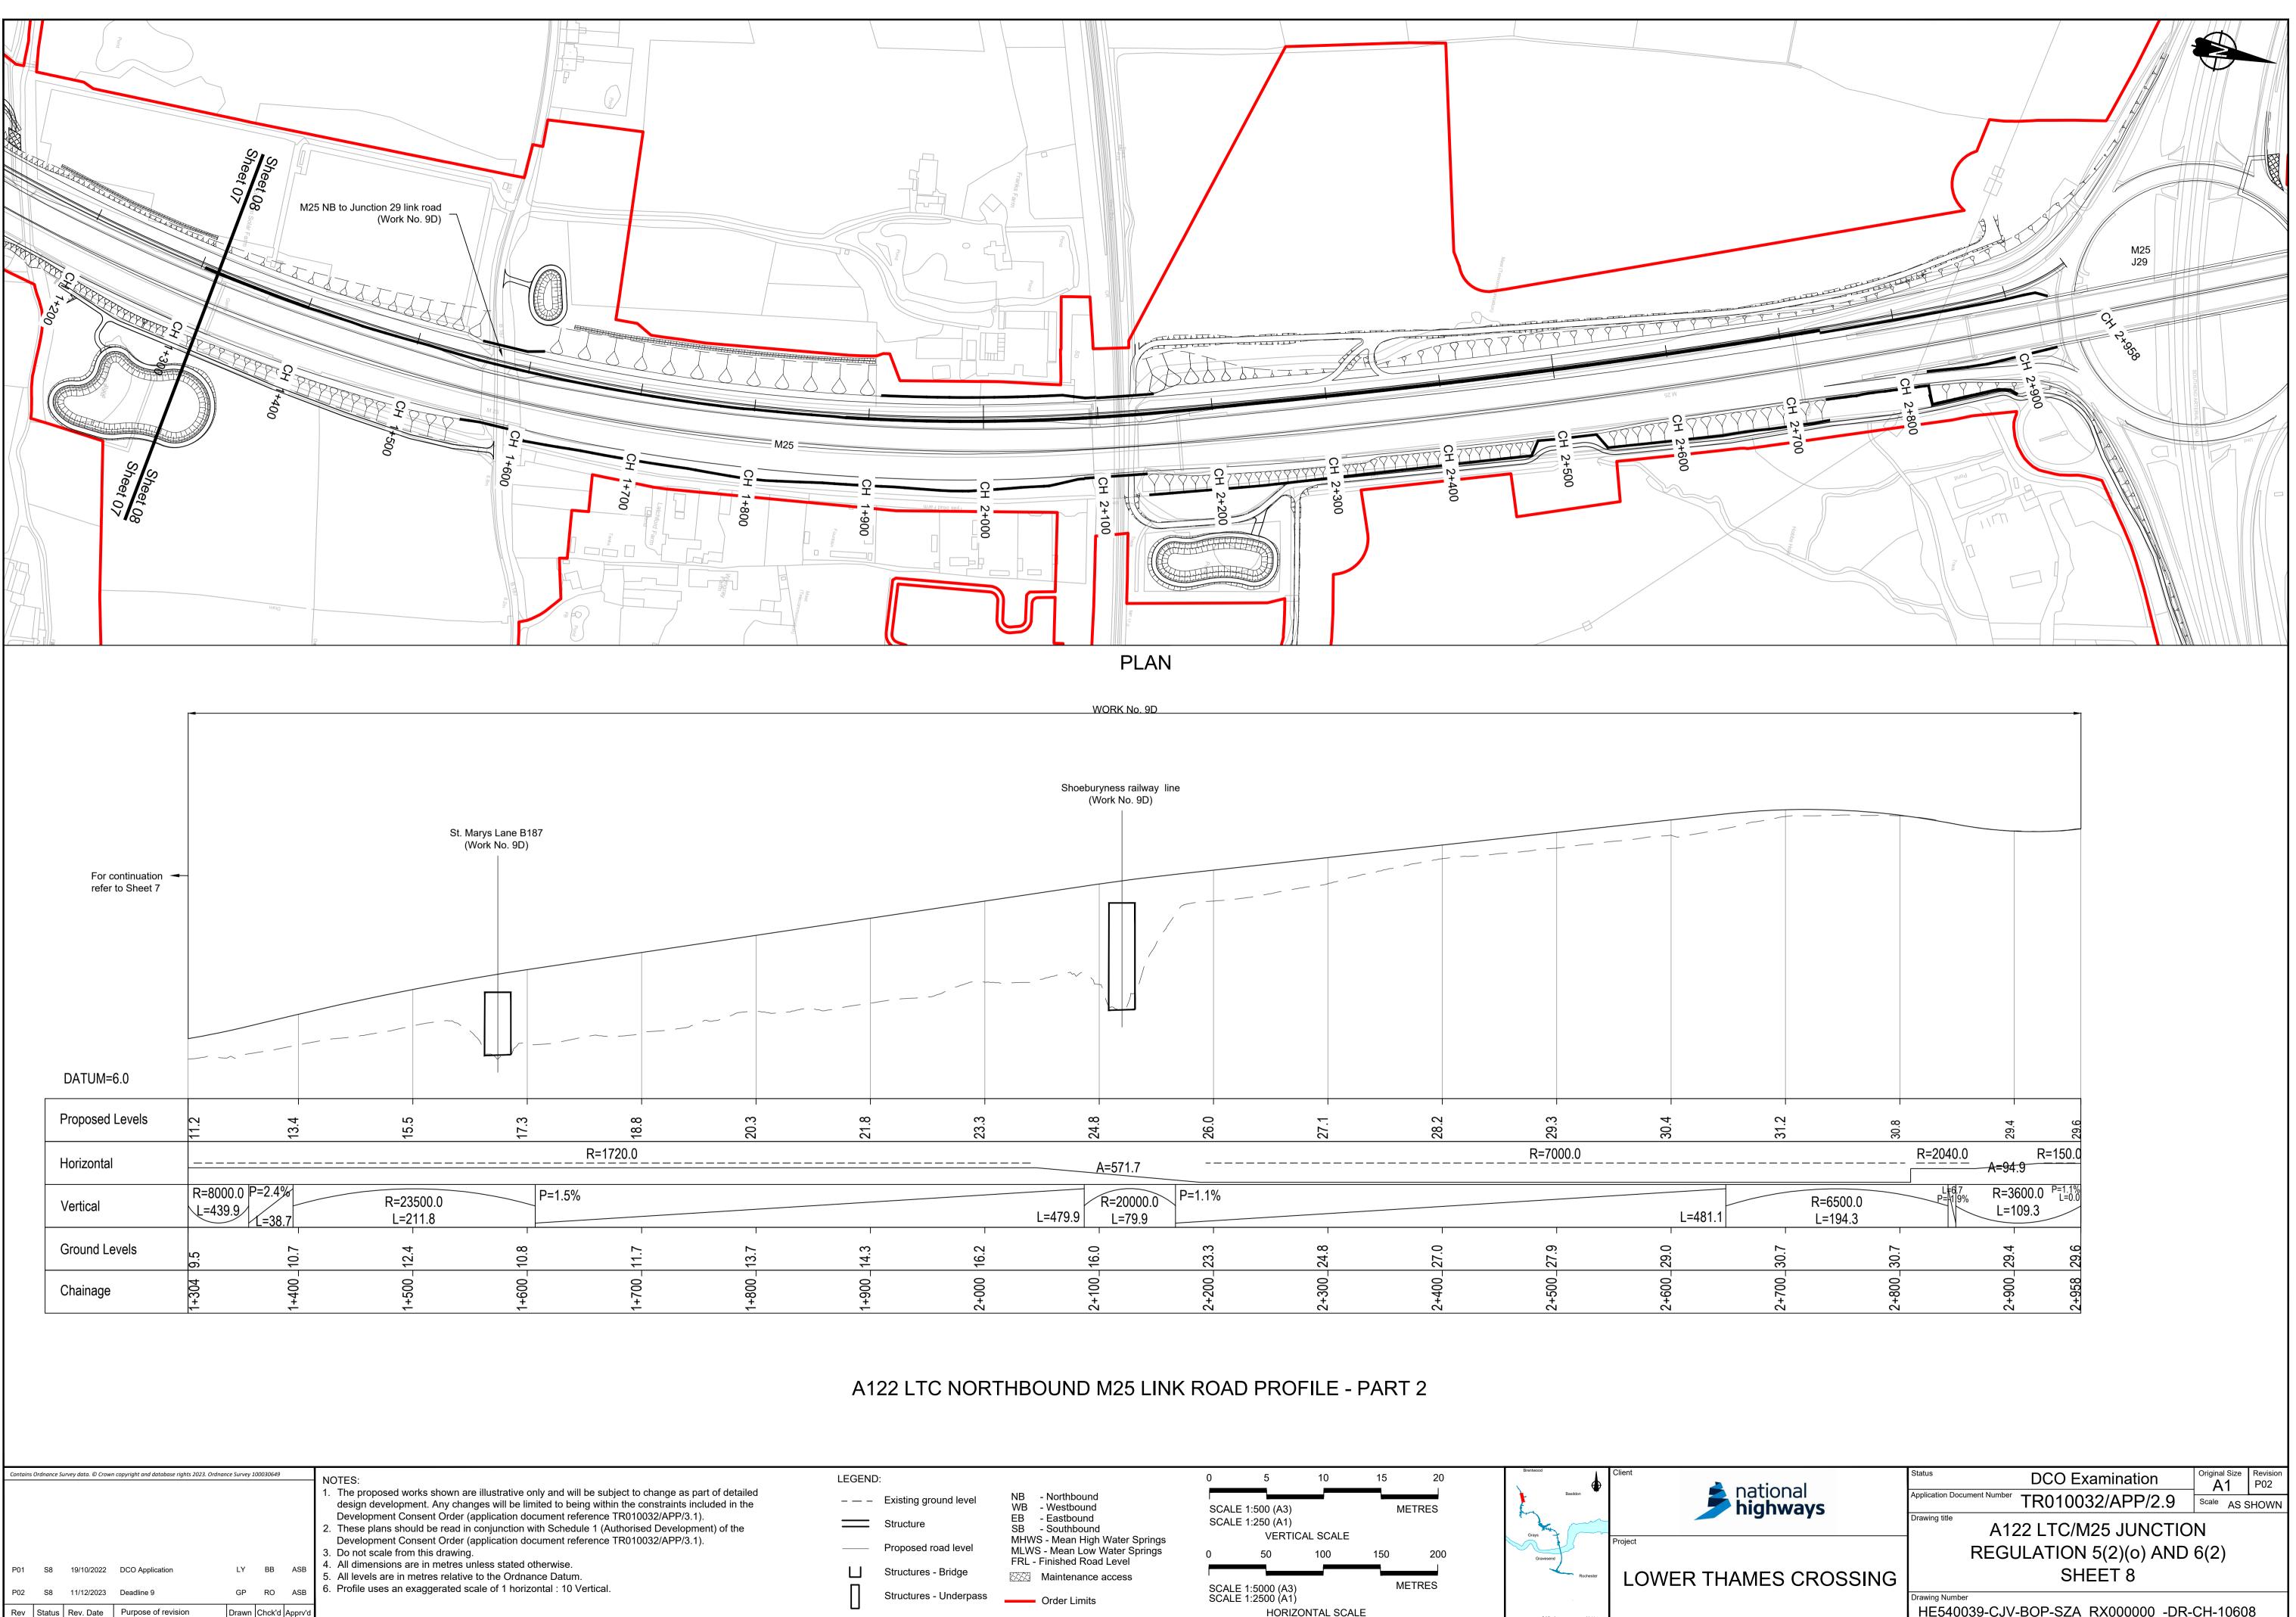




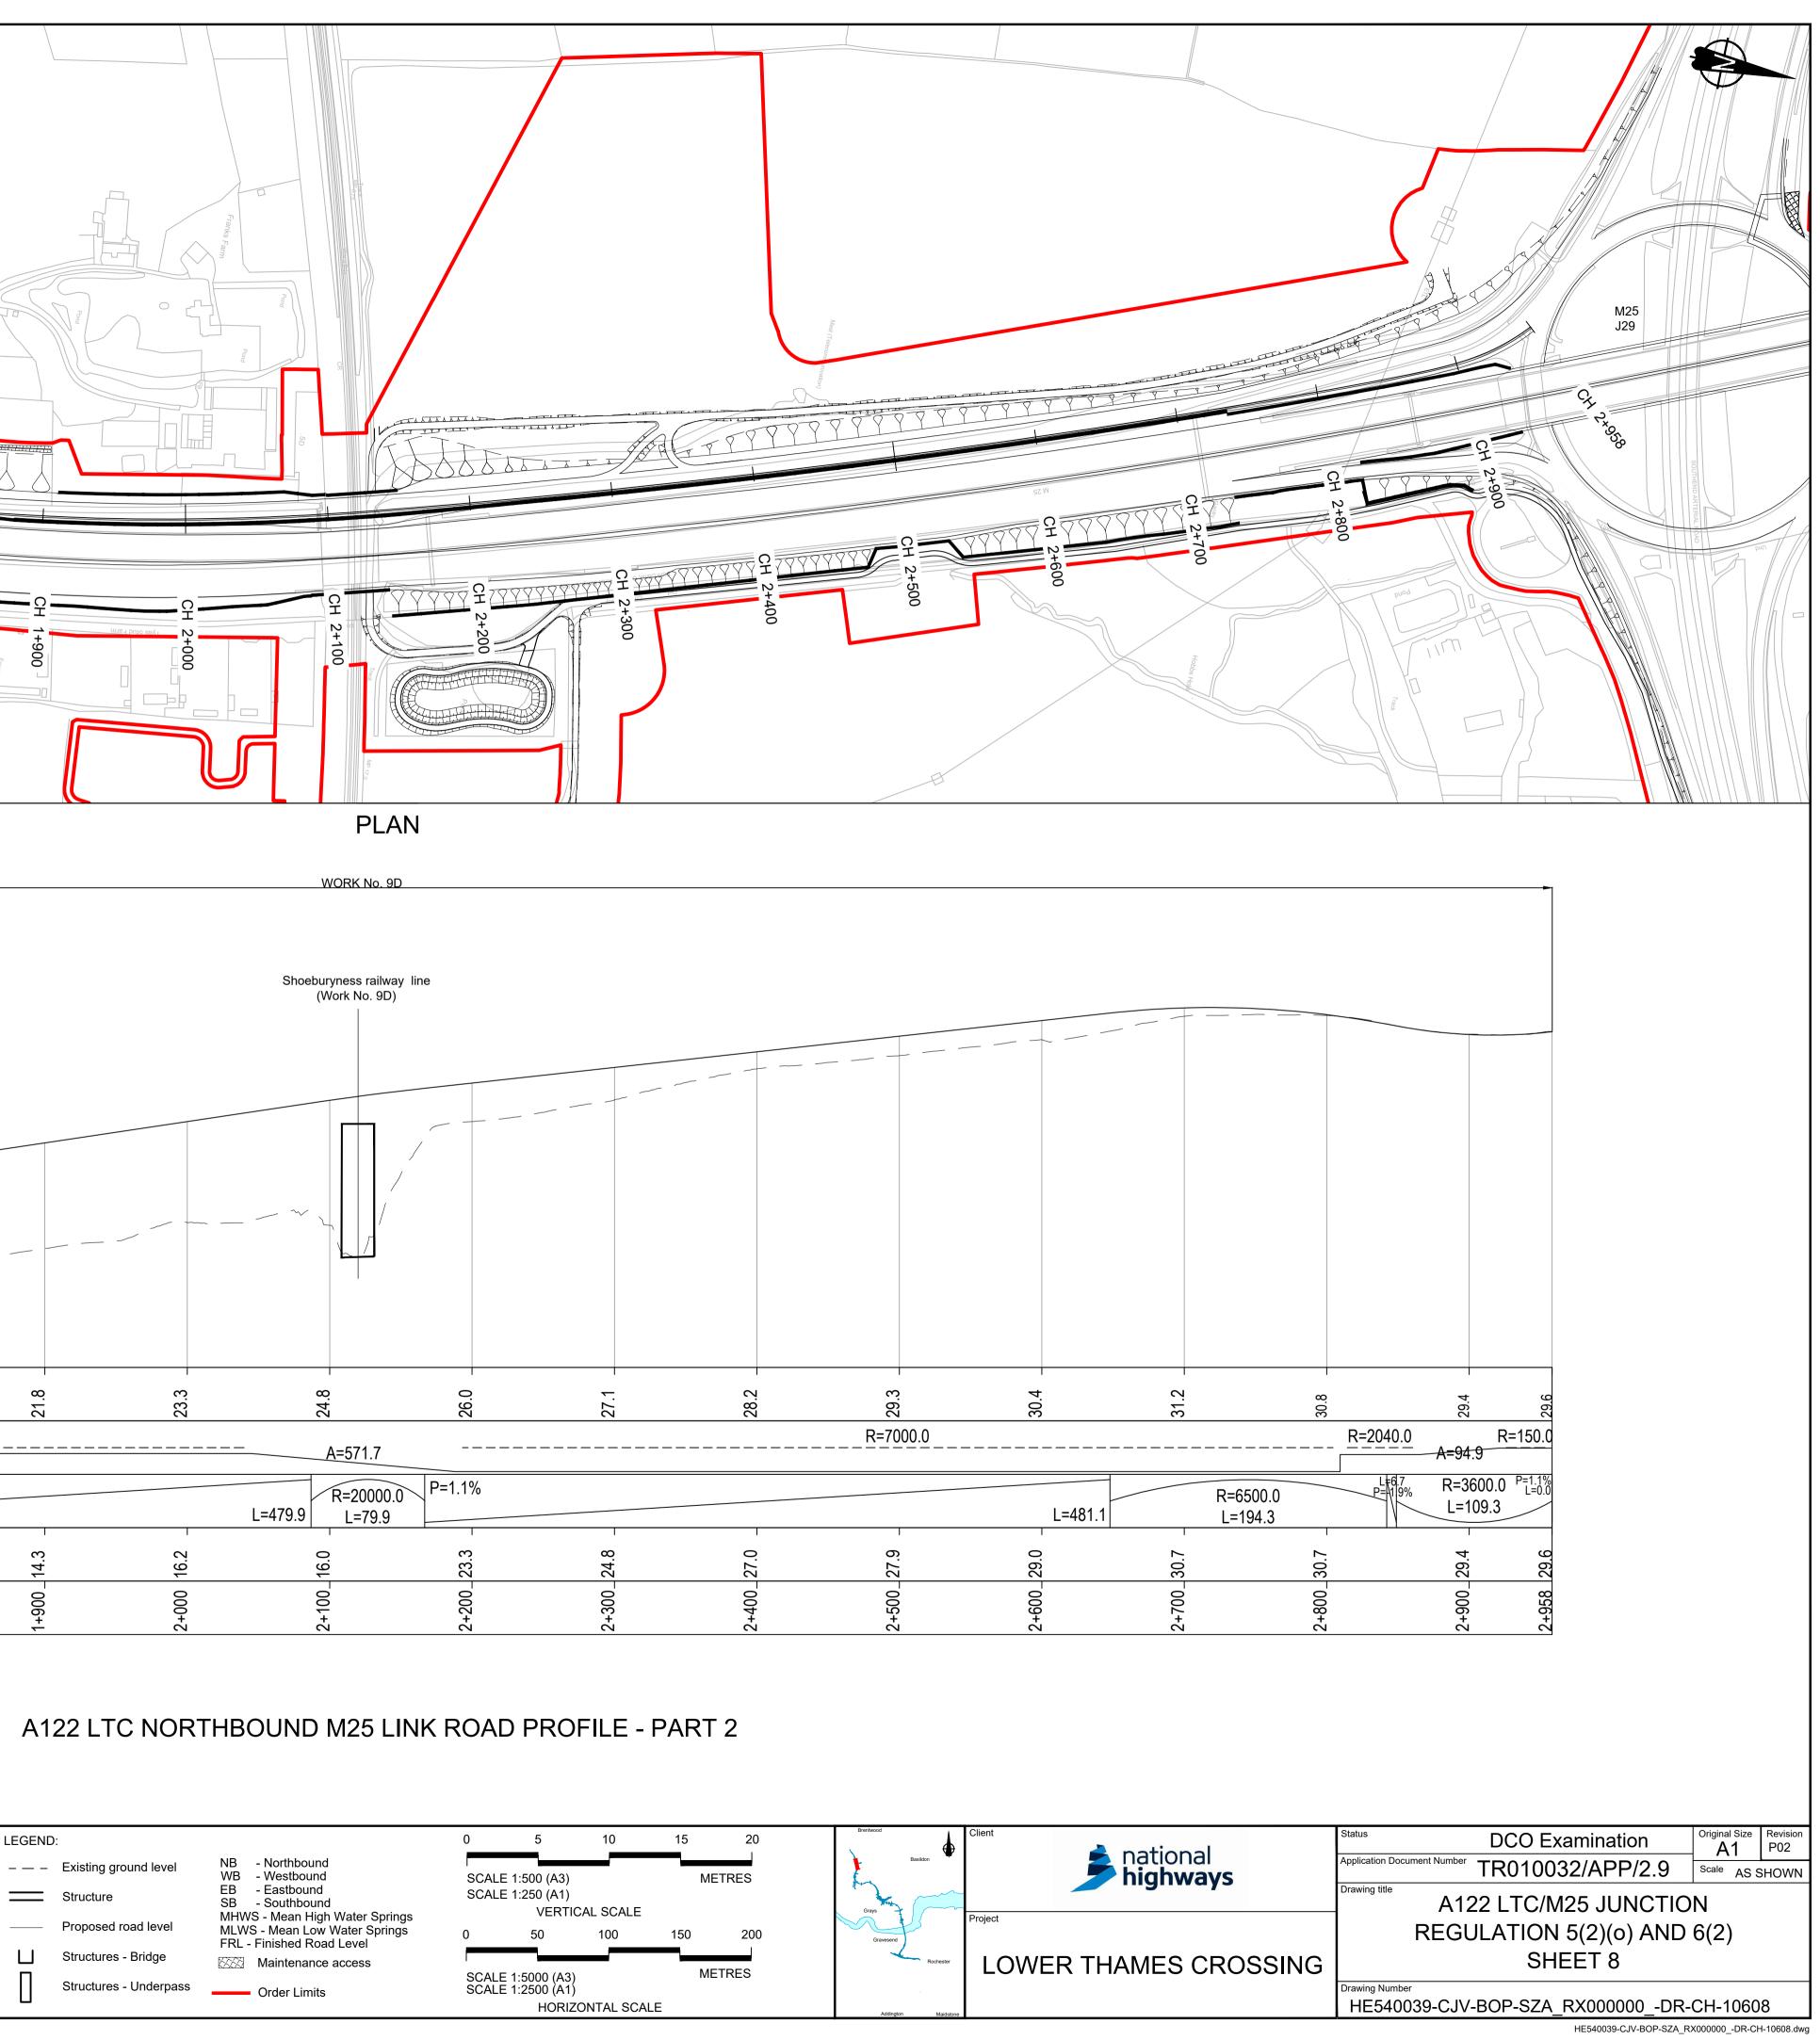


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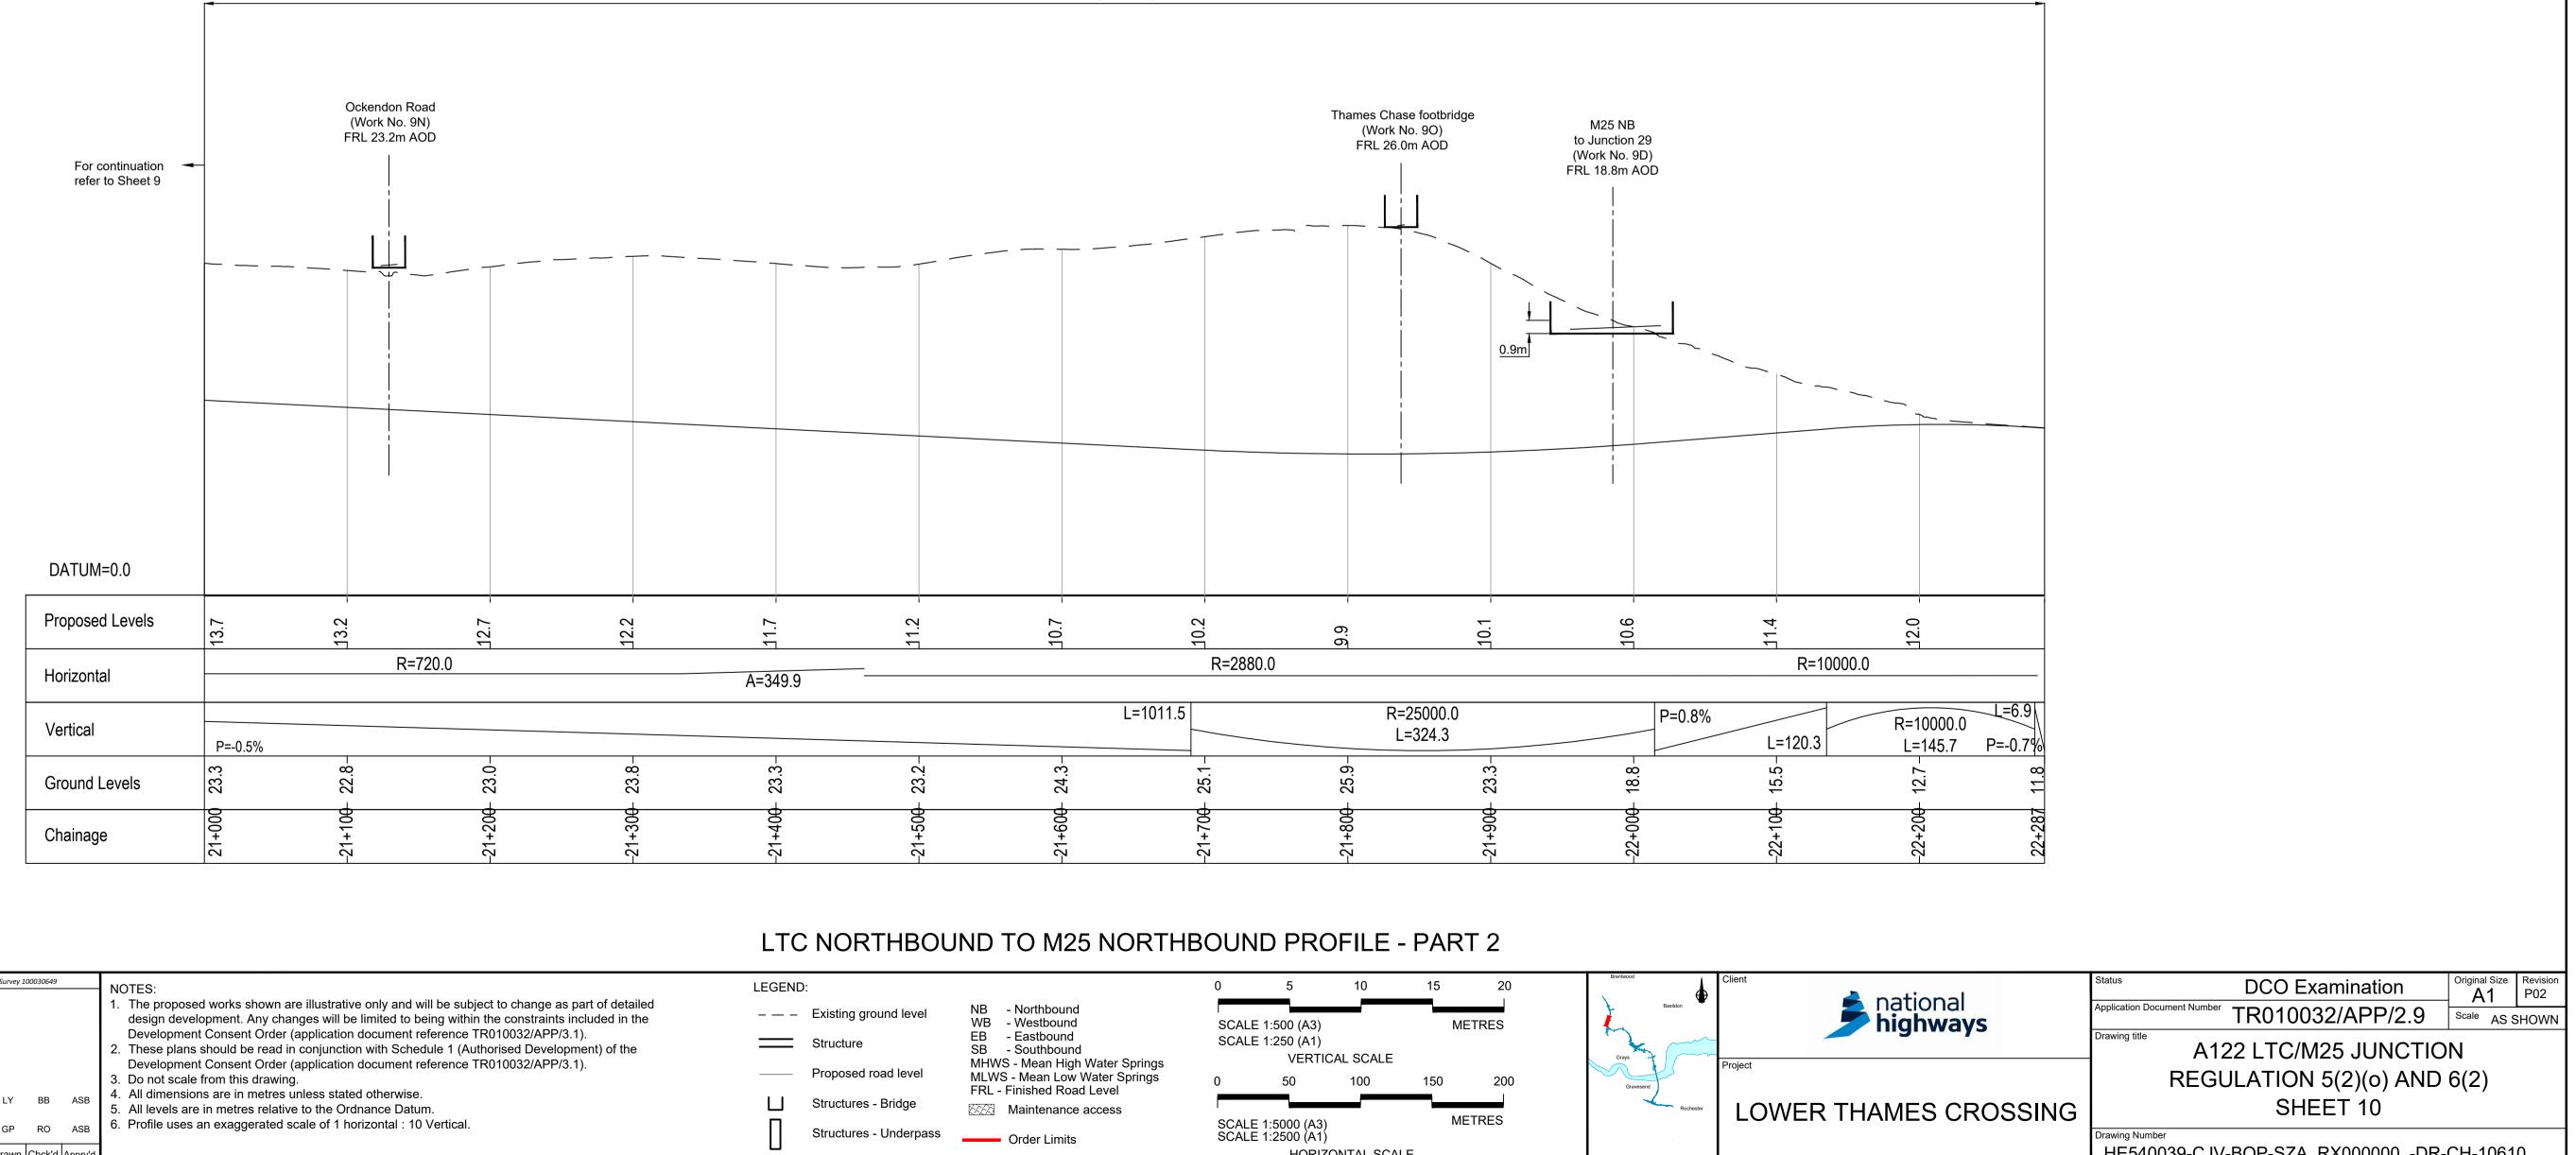
DATUM=0.0						
Proposed Levels	21.8 22.3		22.9		23.2	 23.1
Horizontal			R=144	12.3		 A=
Vertical		50000.0 671.6	L=1.8	P=0.5%		
Ground Levels	- CC	1.22	- 23.0-		- 23.4-	- 23.7-
Chainage	19+611		-19+800		-19+900	 -20+00 <del>0</del> 23.7-

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							<ol> <li>NOTES:</li> <li>The proposed works shown are illustrative only and will be subject to change as part of detailed design development. Any changes will be limited to being within the constraints included in the Development Consent Order (application document reference TR010032/APP/3.1).</li> <li>These plans should be read in conjunction with Schedule 1 (Authorised Development) of the Development Consent Order (application document reference TR010032/APP/3.1).</li> <li>Do not scale from this drawing.</li> </ol>			
P01	S8	19/10/2022	DCO Application	LY	BB	ASB	<ol> <li>All dimensions are in metres unless stated otherwise.</li> <li>All levels are in metres relative to the Ordnance Datum.</li> </ol>			
P02	S8	11/12/2023	Deadline 9	GP	RO	ASB	6. Profile uses an exaggerated scale of 1 horizontal : 10 Vertical.			
Rev	Status	Rev. Date	Purpose of revision	Drawn	Chck'd	Apprv'd				

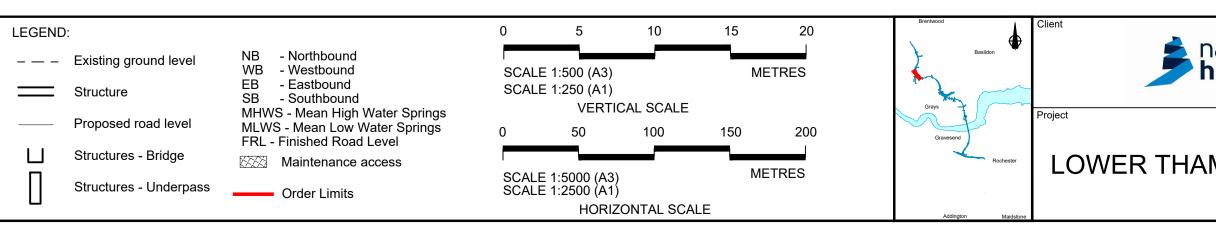

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national <b>highways</b>	Application Document Number TR010032/APP/2.9	Scale AS SHOWN						
inginiay5	Drawing title A122 LTC/M25 JUNCTION							
	REGULATION 5(2)(0) AND	6(2)						
MES CROSSING	SHEET 9							
	Drawing Number HE540039-CJV-BOP-SZA_RX000000DR-	CH-10609						
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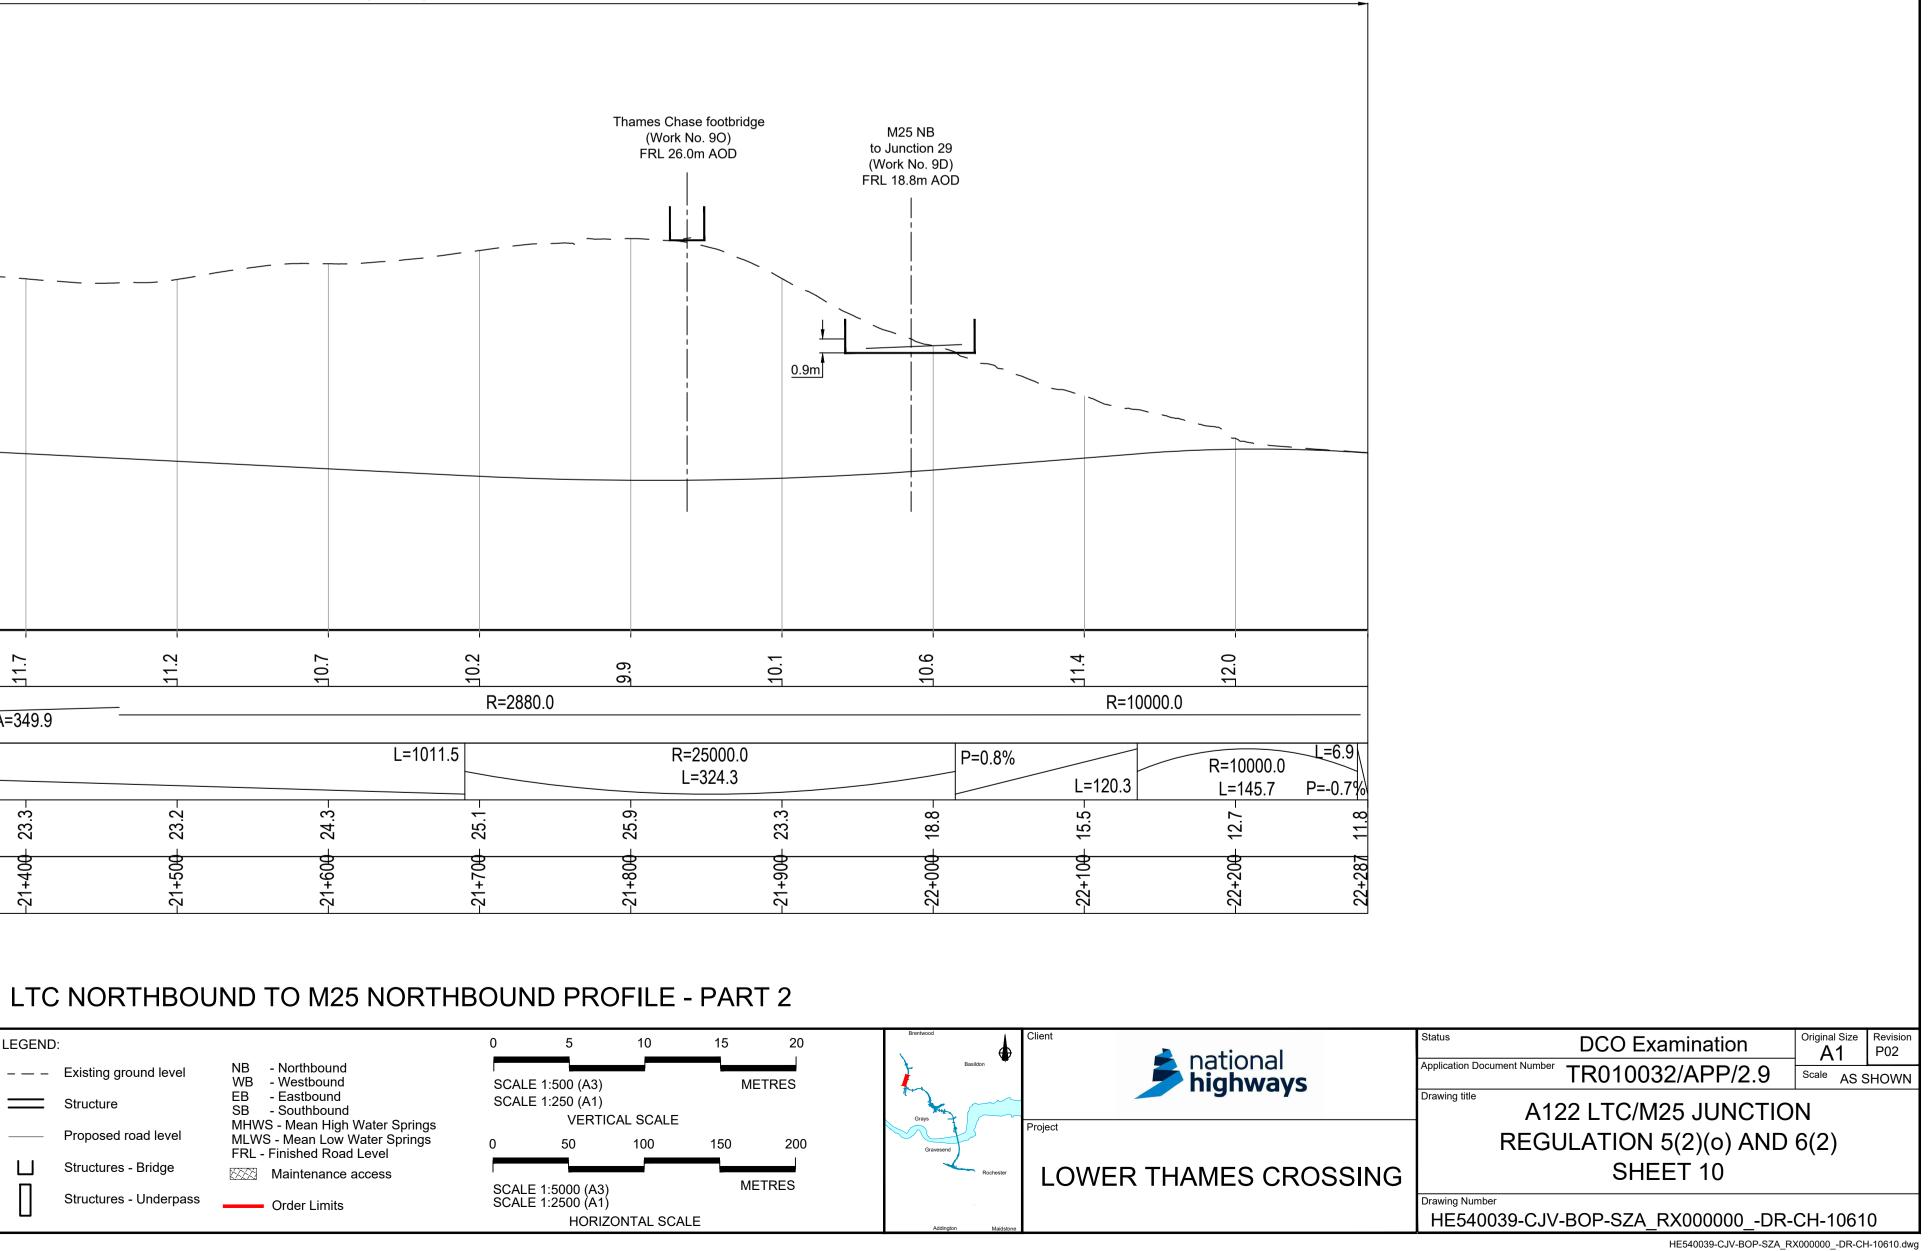


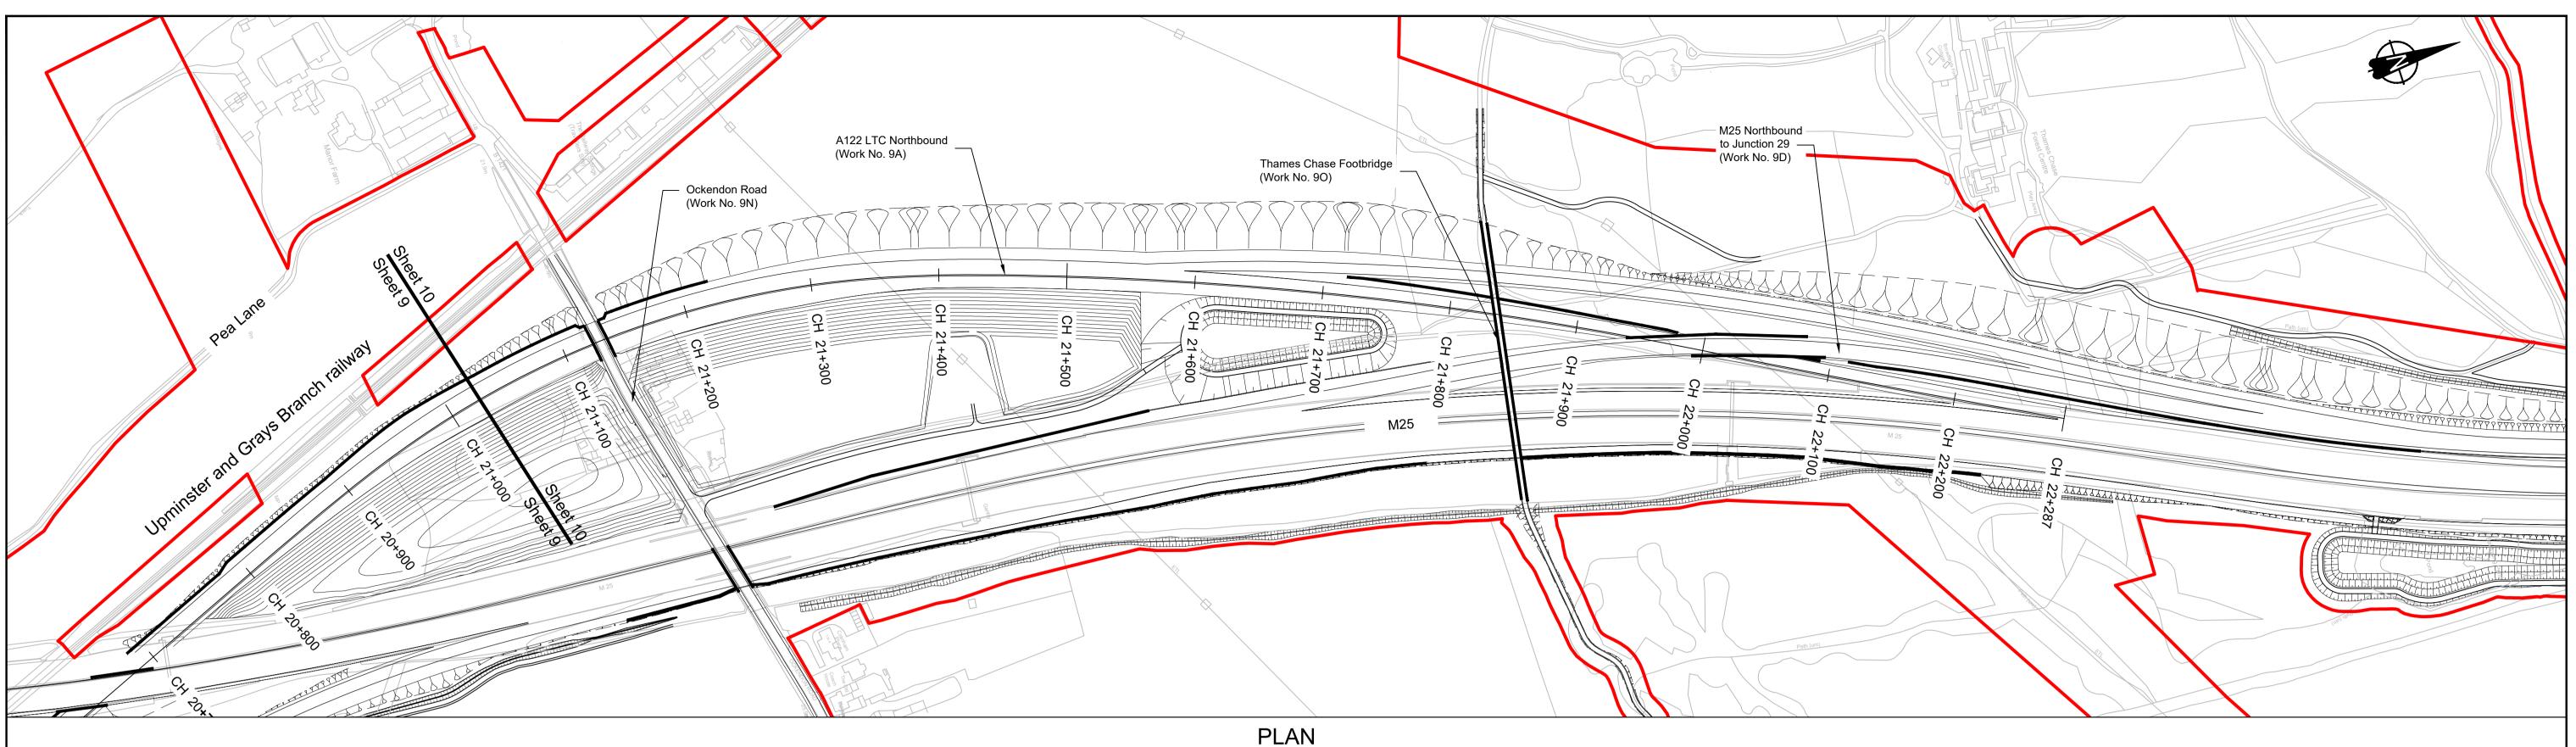


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P01	S8	19/10/2022	DCO Application	LY	BB	ASB	<ol> <li>The proposed works shown are illustrative only and will be subject to change as part of detailed design development. Any changes will be limited to being within the constraints included in the Development Consent Order (application document reference TR010032/APP/3.1).</li> <li>These plans should be read in conjunction with Schedule 1 (Authorised Development) of the Development Consent Order (application document reference TR010032/APP/3.1).</li> <li>Do not scale from this drawing.</li> <li>All dimensions are in metres unless stated otherwise.</li> <li>All levels are in metres relative to the Ordnance Datum.</li> <li>Profile uses an exaggerated scale of 1 horizontal : 10 Vertical.</li> </ol>
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Rev	Status	Rev. Date	Purpose of revision	Drawn	Chck'd	Apprv'd	


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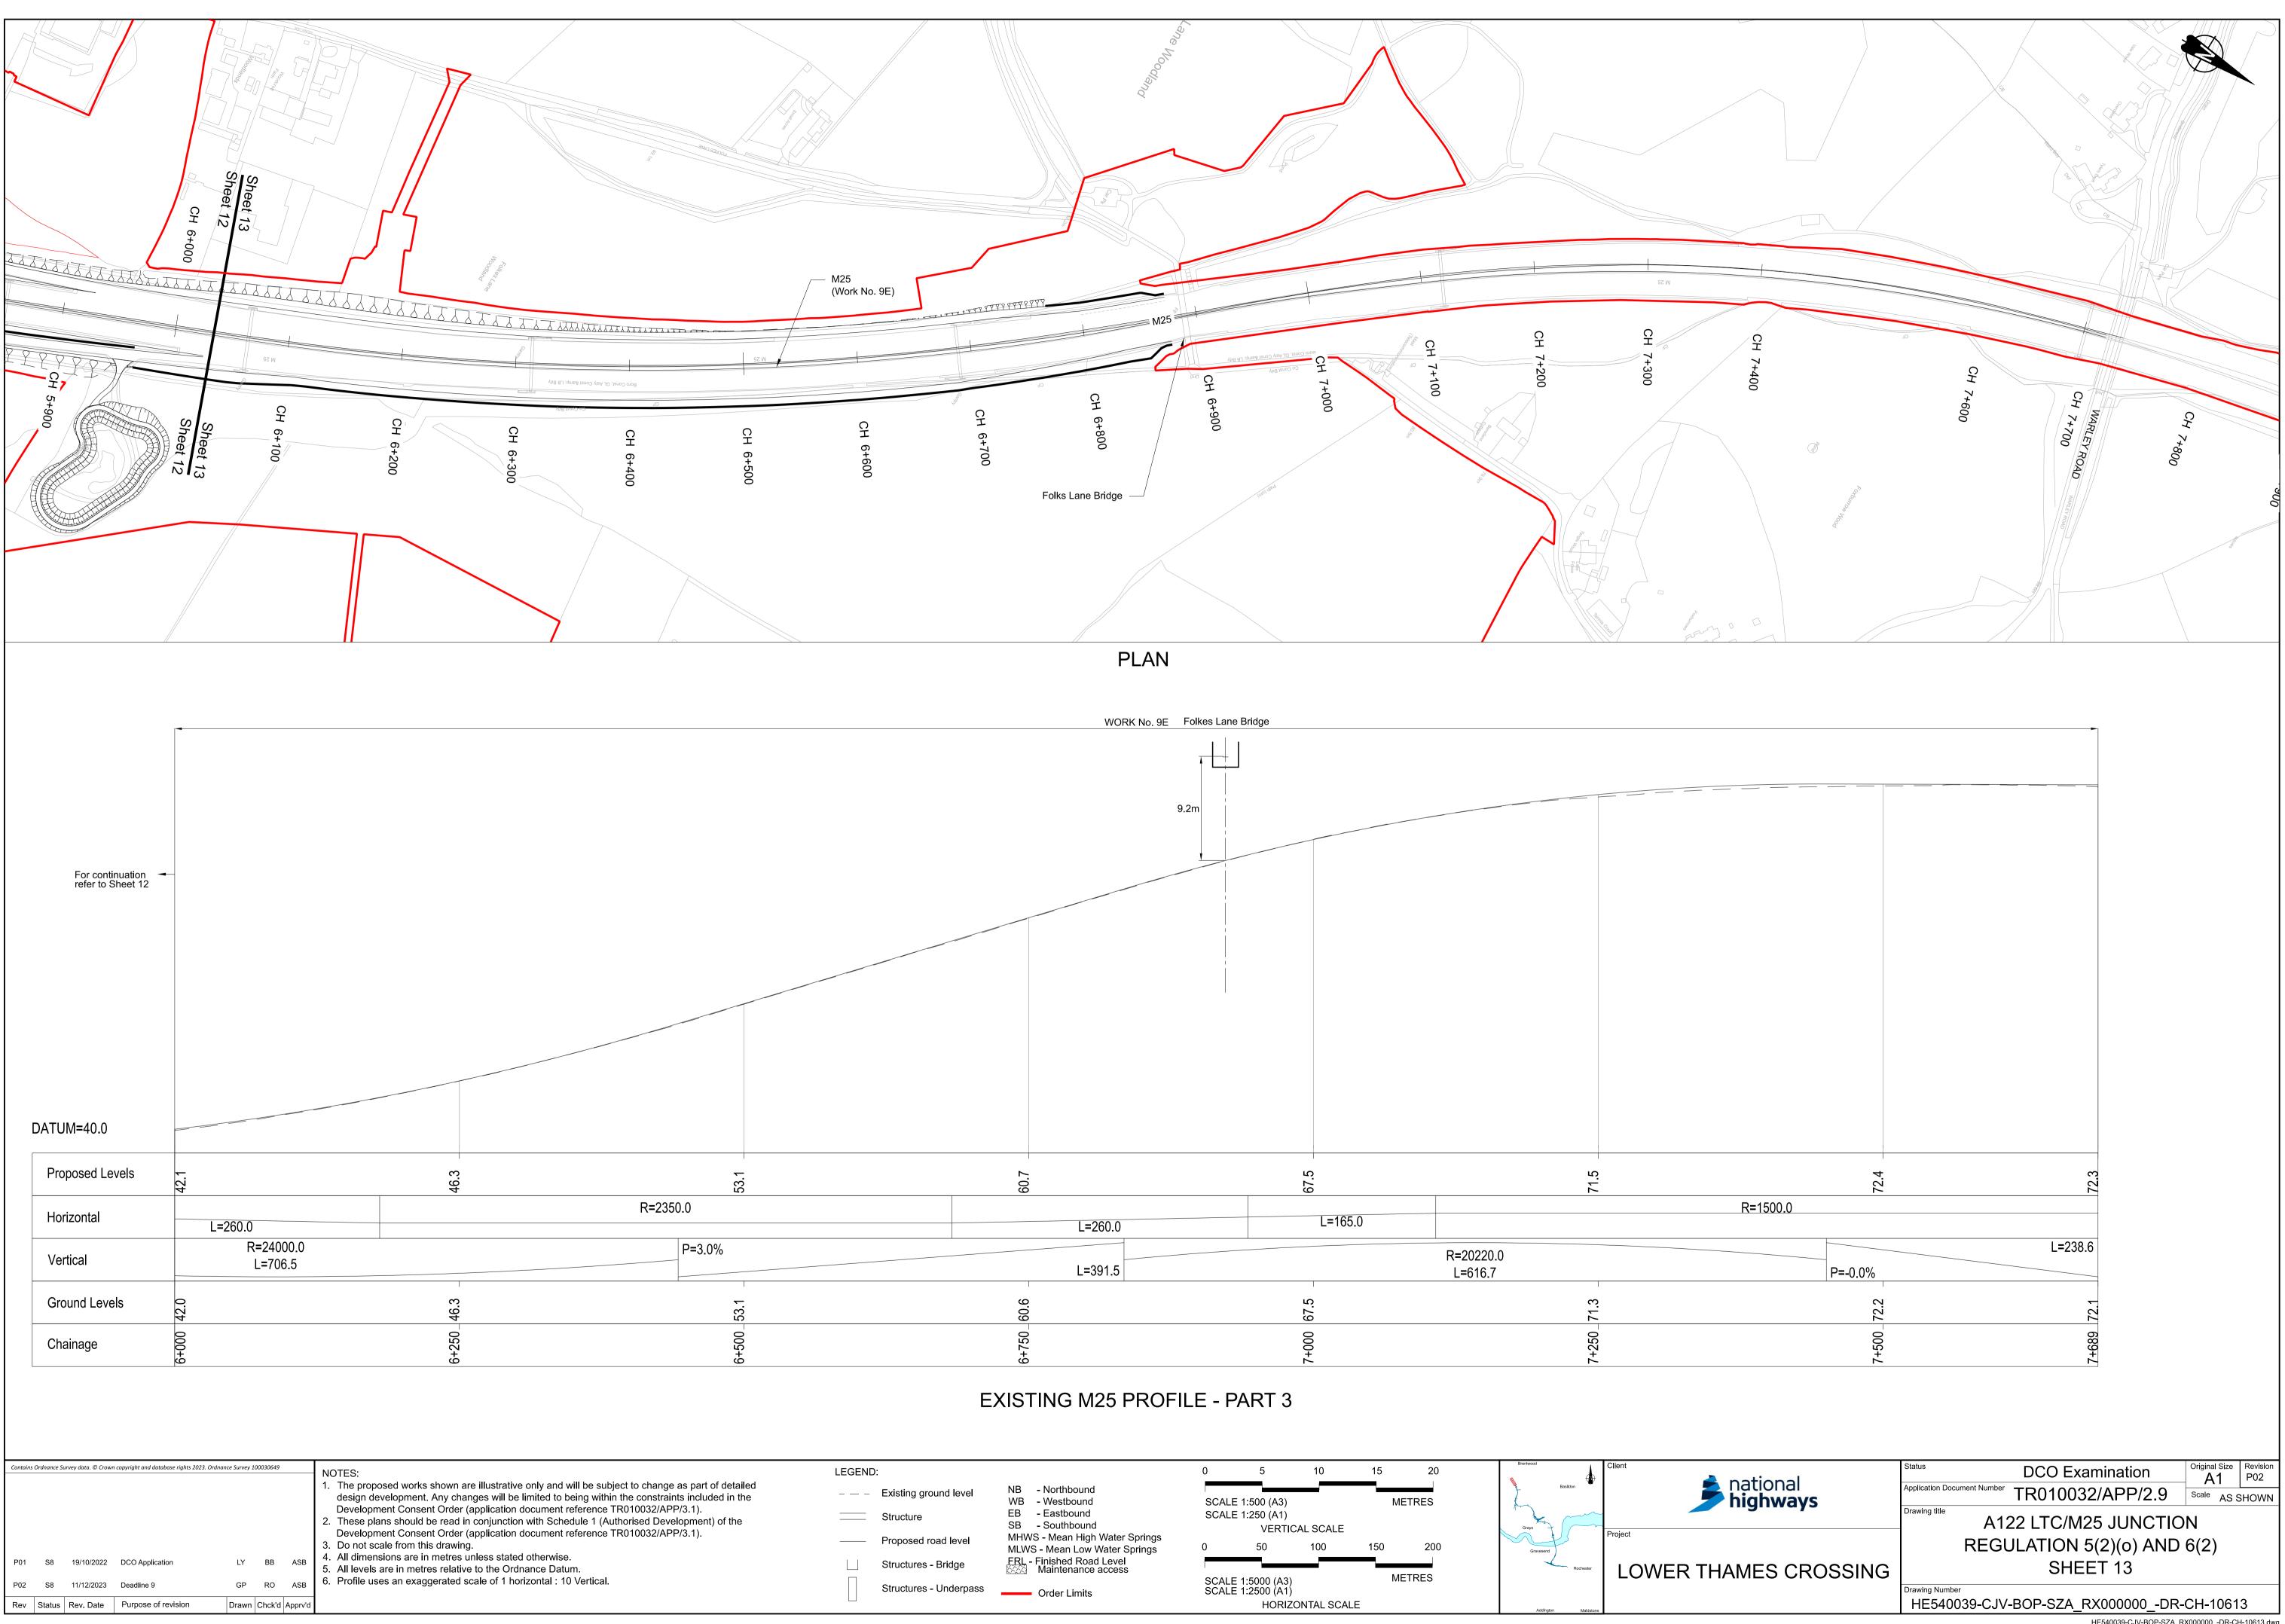
WORK No. 9A




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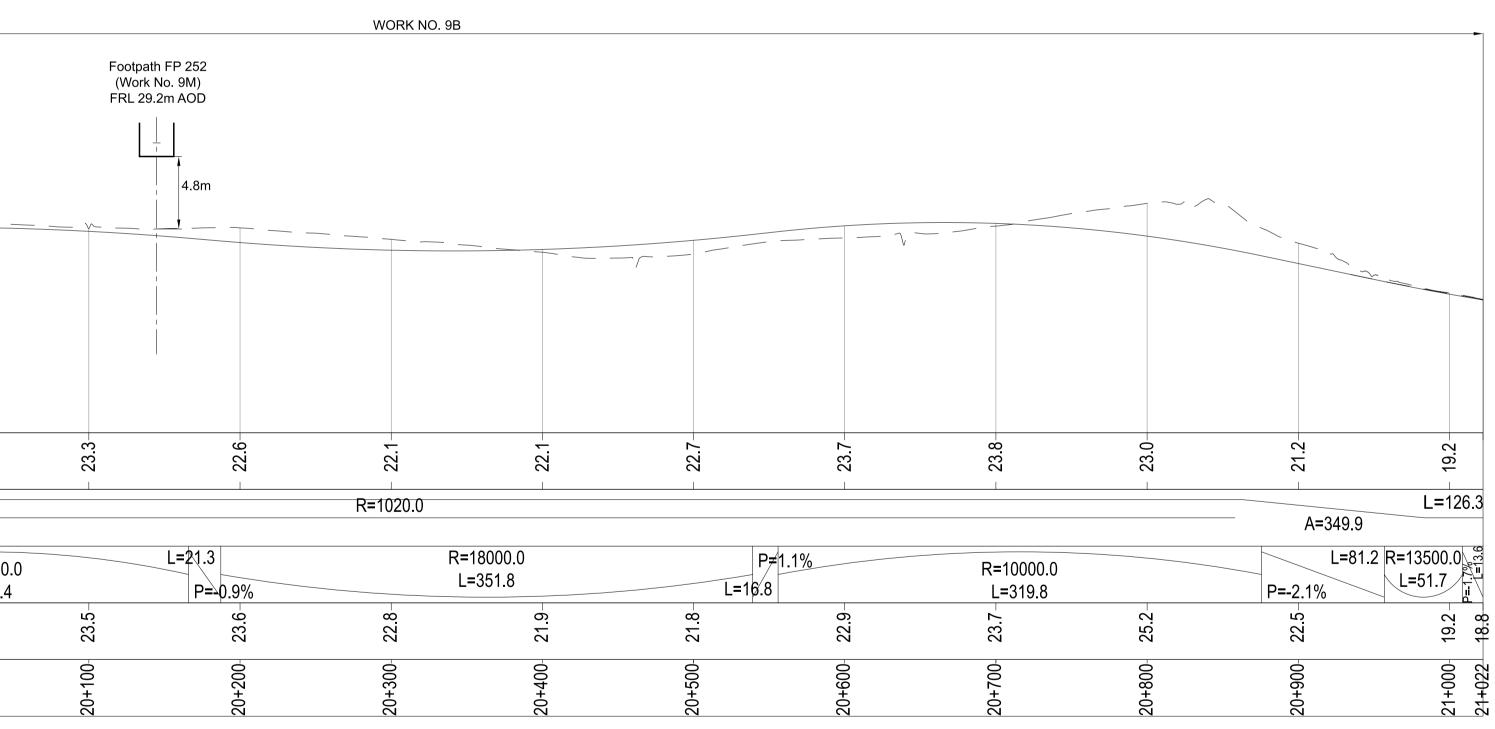


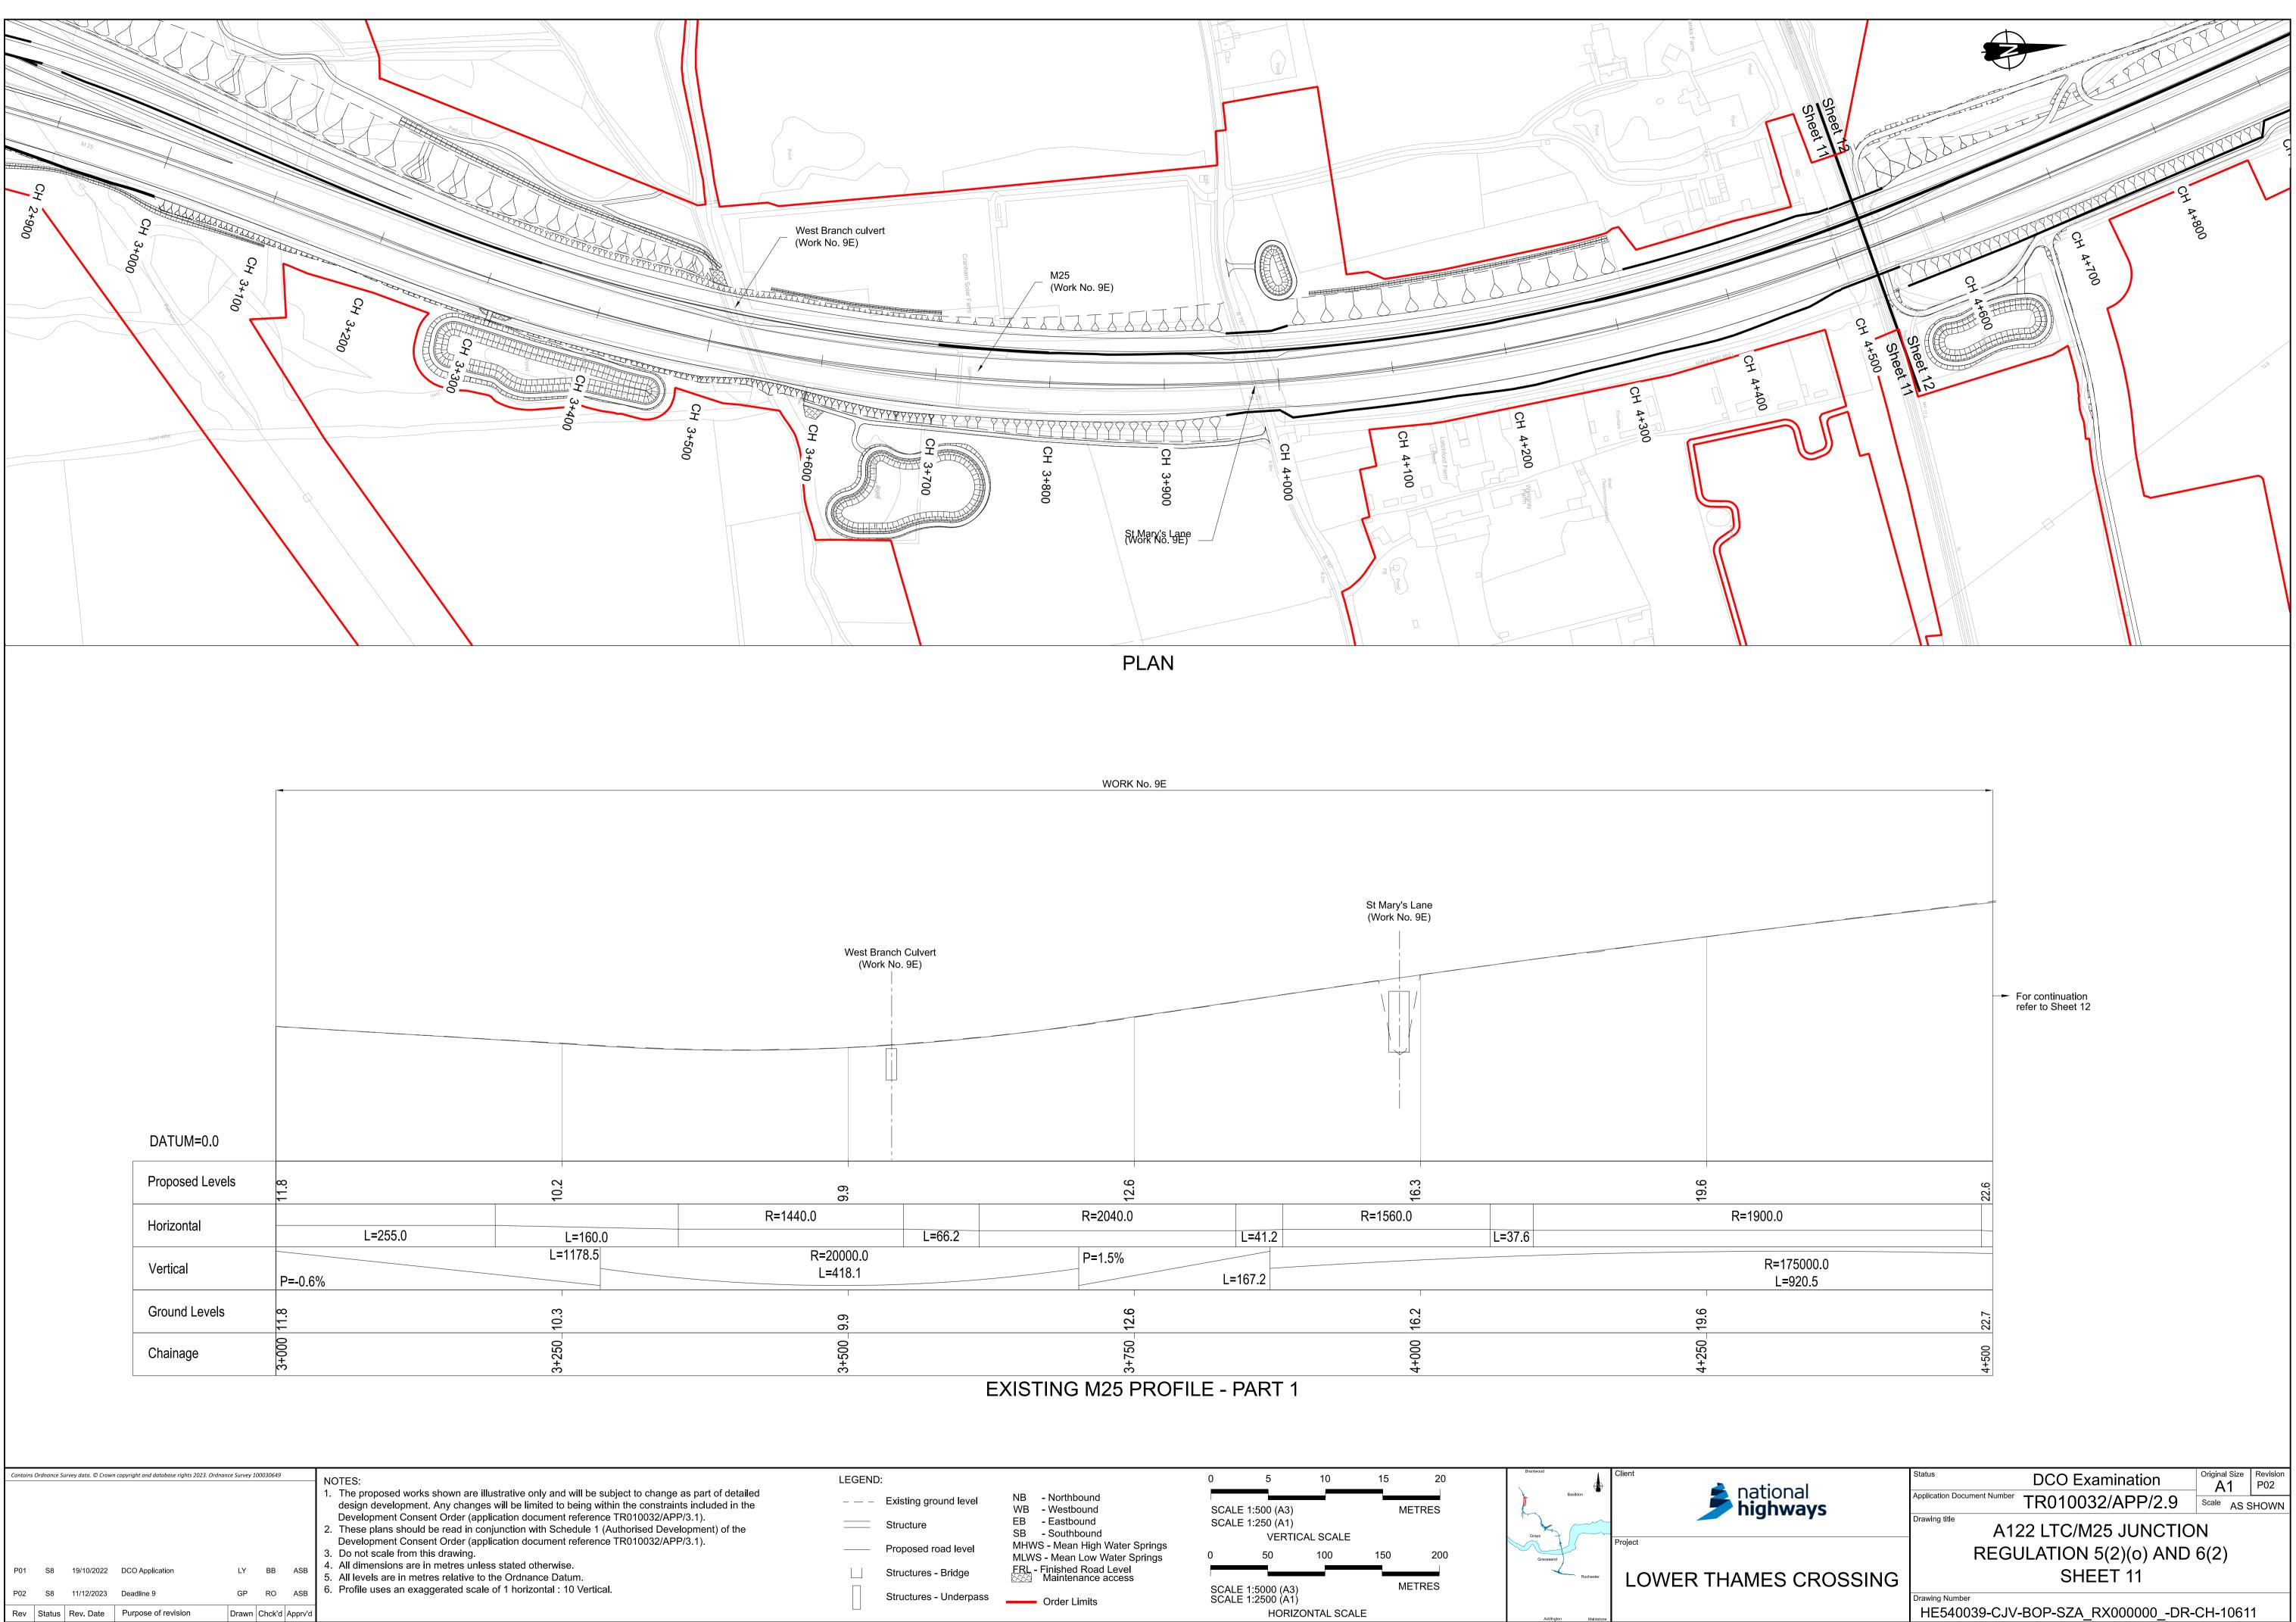


DATUM=10.0	<u>φ</u> .	n.	<u>ර</u> .	4.	9.
Proposed Levels Horizontal	R=1434.0	A=351.6	- 22.9-	- 23.4	- 23.6-
Vertical		50000.0 =671.6	P=0.5%	9	R=20000. L=270.4
Ground Levels		-8-27	23.1-	23.5-	23.9-
Chainage	19+611	-007+91	19+800-	19+900-	20+000-

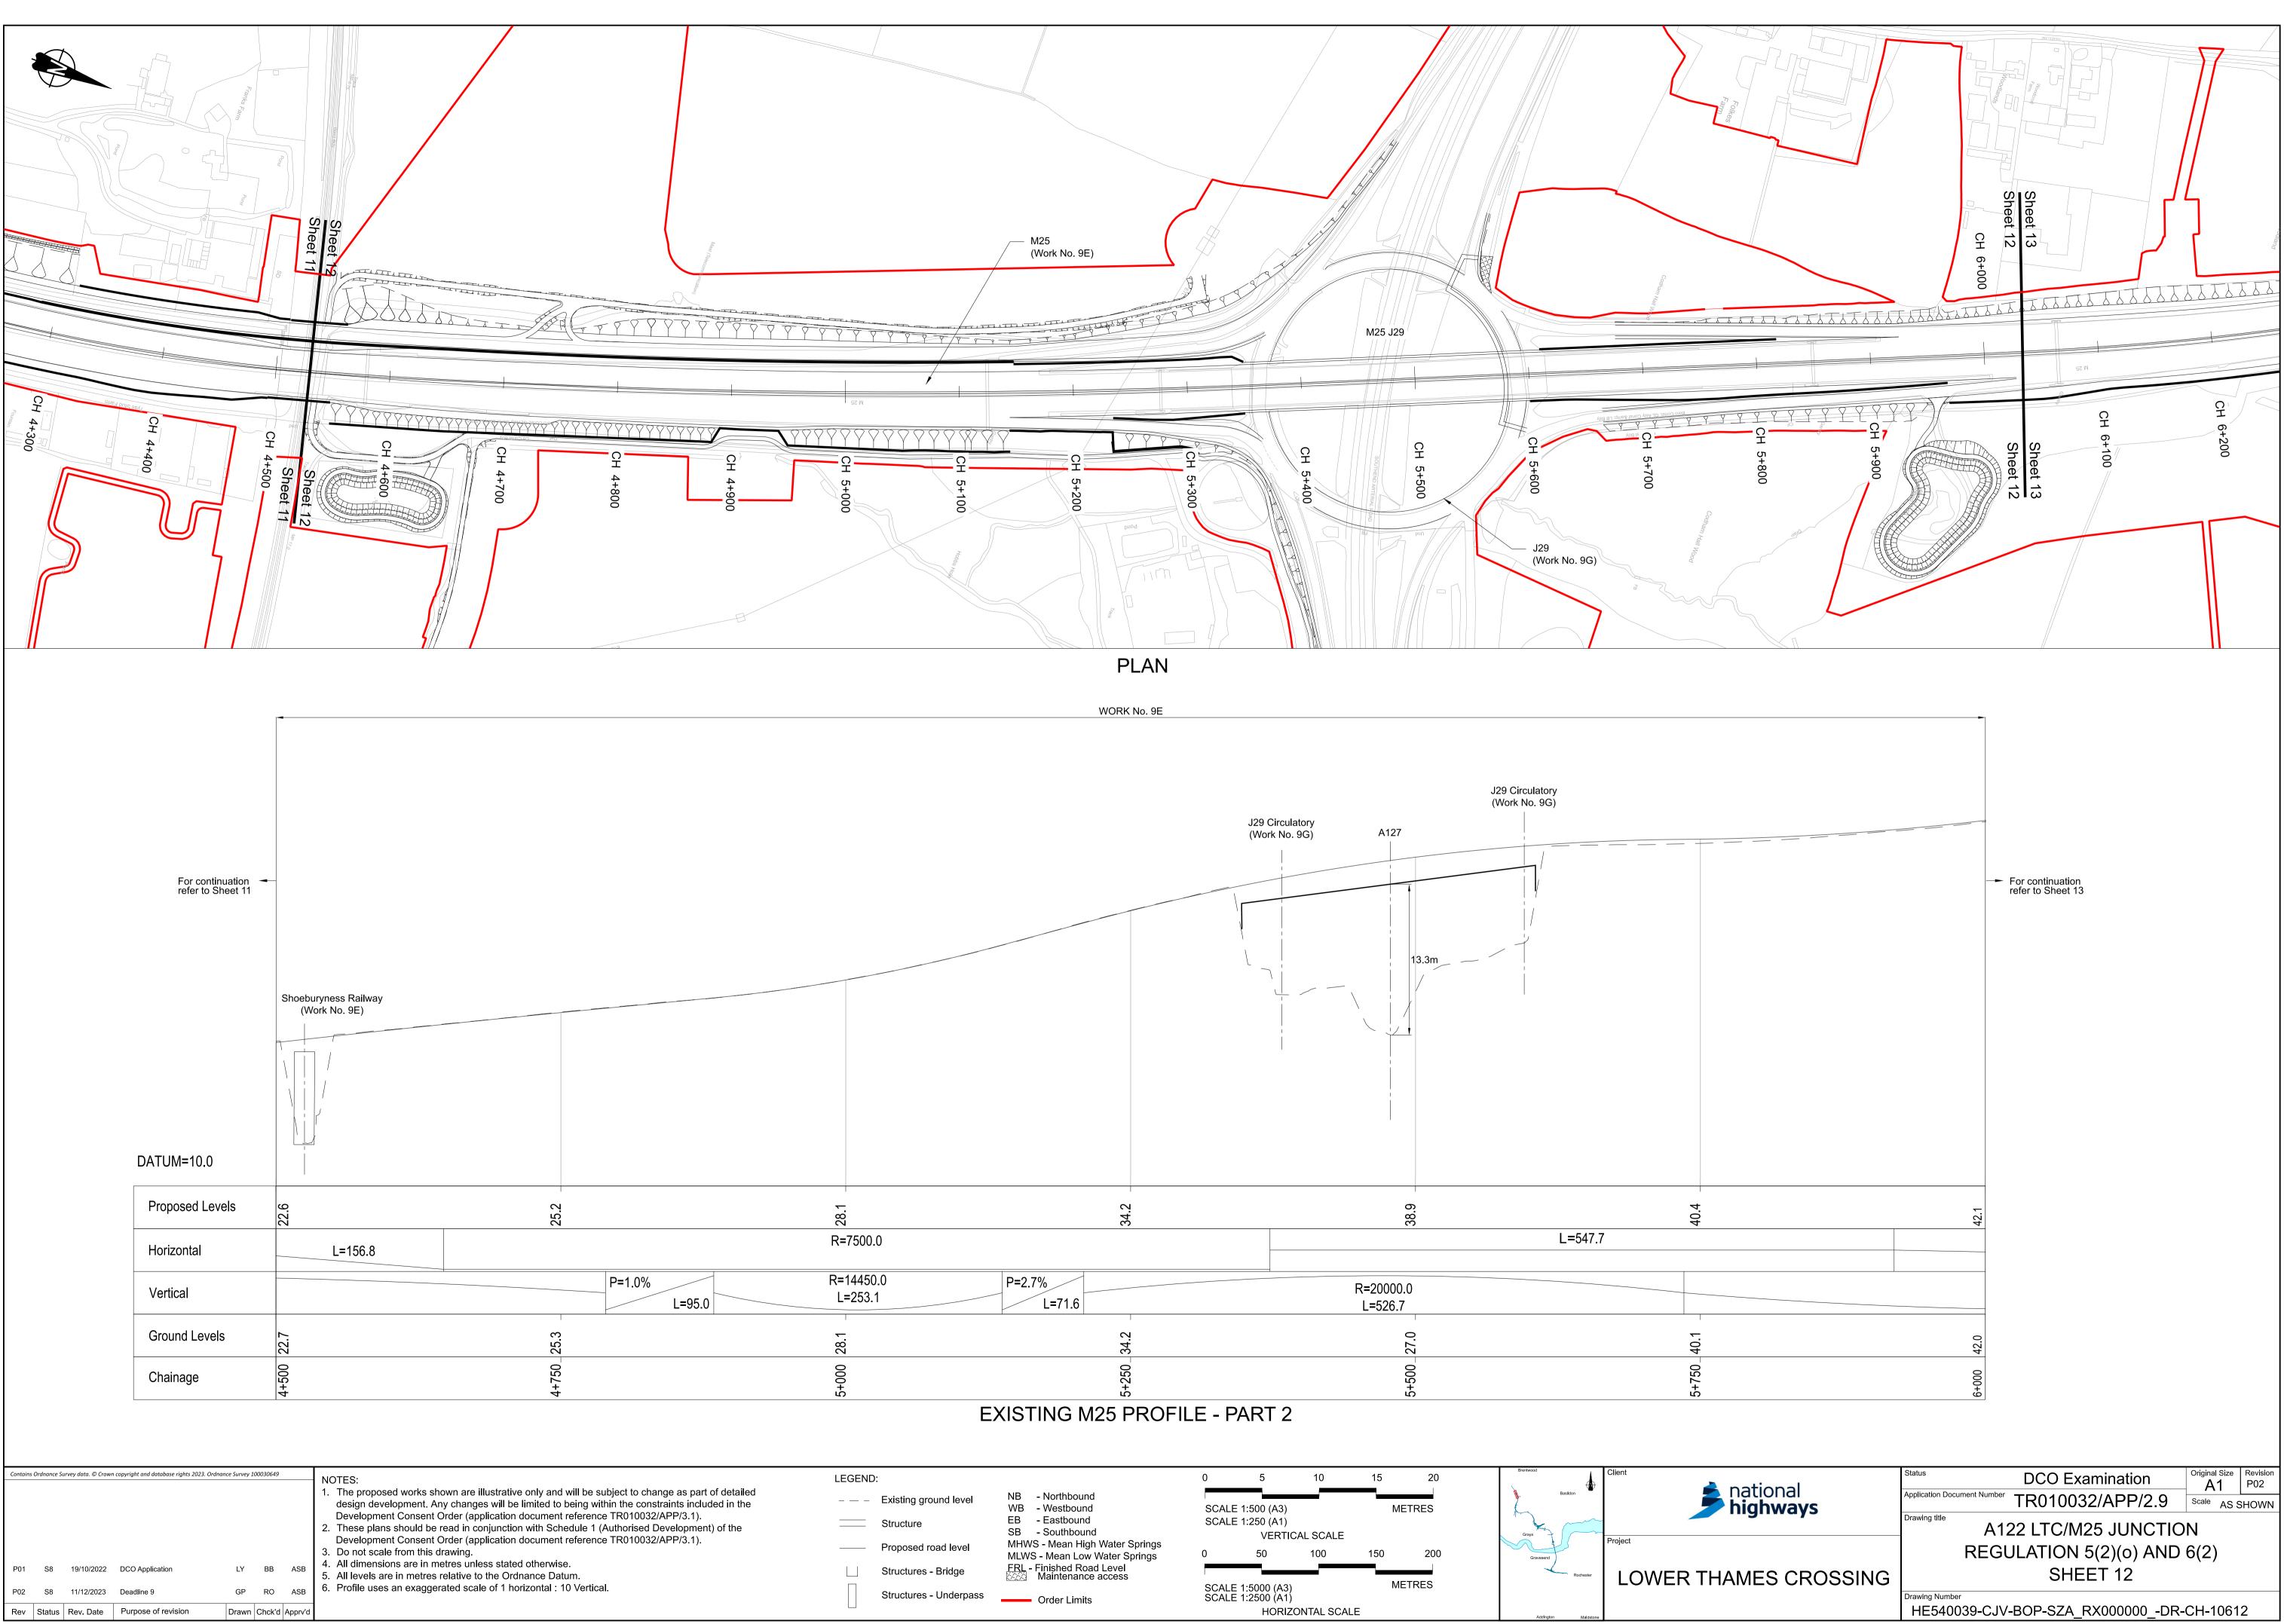Contains	Ordnance Su	urvey data. © Crowi	n copyright and database rights 2023. Ordnai	nce Survey .	100030649		NOTES: 1. The proposed works shown are illustrative only and will be subject to change as part of detailed
							<ul> <li>design development. Any changes will be limited to being within the constraints included in the Development Consent Order (application document reference TR010032/APP/3.1).</li> <li>These plans should be read in conjunction with Schedule 1 (Authorised Development) of the Development Consent Order (application document reference TR010032/APP/3.1).</li> <li>Do not scale from this drawing.</li> </ul>
P01	S8	19/10/2022	DCO Application	LY	BB	ASB	<ol> <li>All dimensions are in metres unless stated otherwise.</li> <li>All levels are in metres relative to the Ordnance Datum.</li> </ol>
P02	S8	11/12/2023	Deadline 9	GP	RO	ASB	6. Profile uses an exaggerated scale of 1 horizontal : 10 Vertical.
Rev	Status	Rev. Date	Purpose of revision	Drawn	Chck'd	Apprv'd	
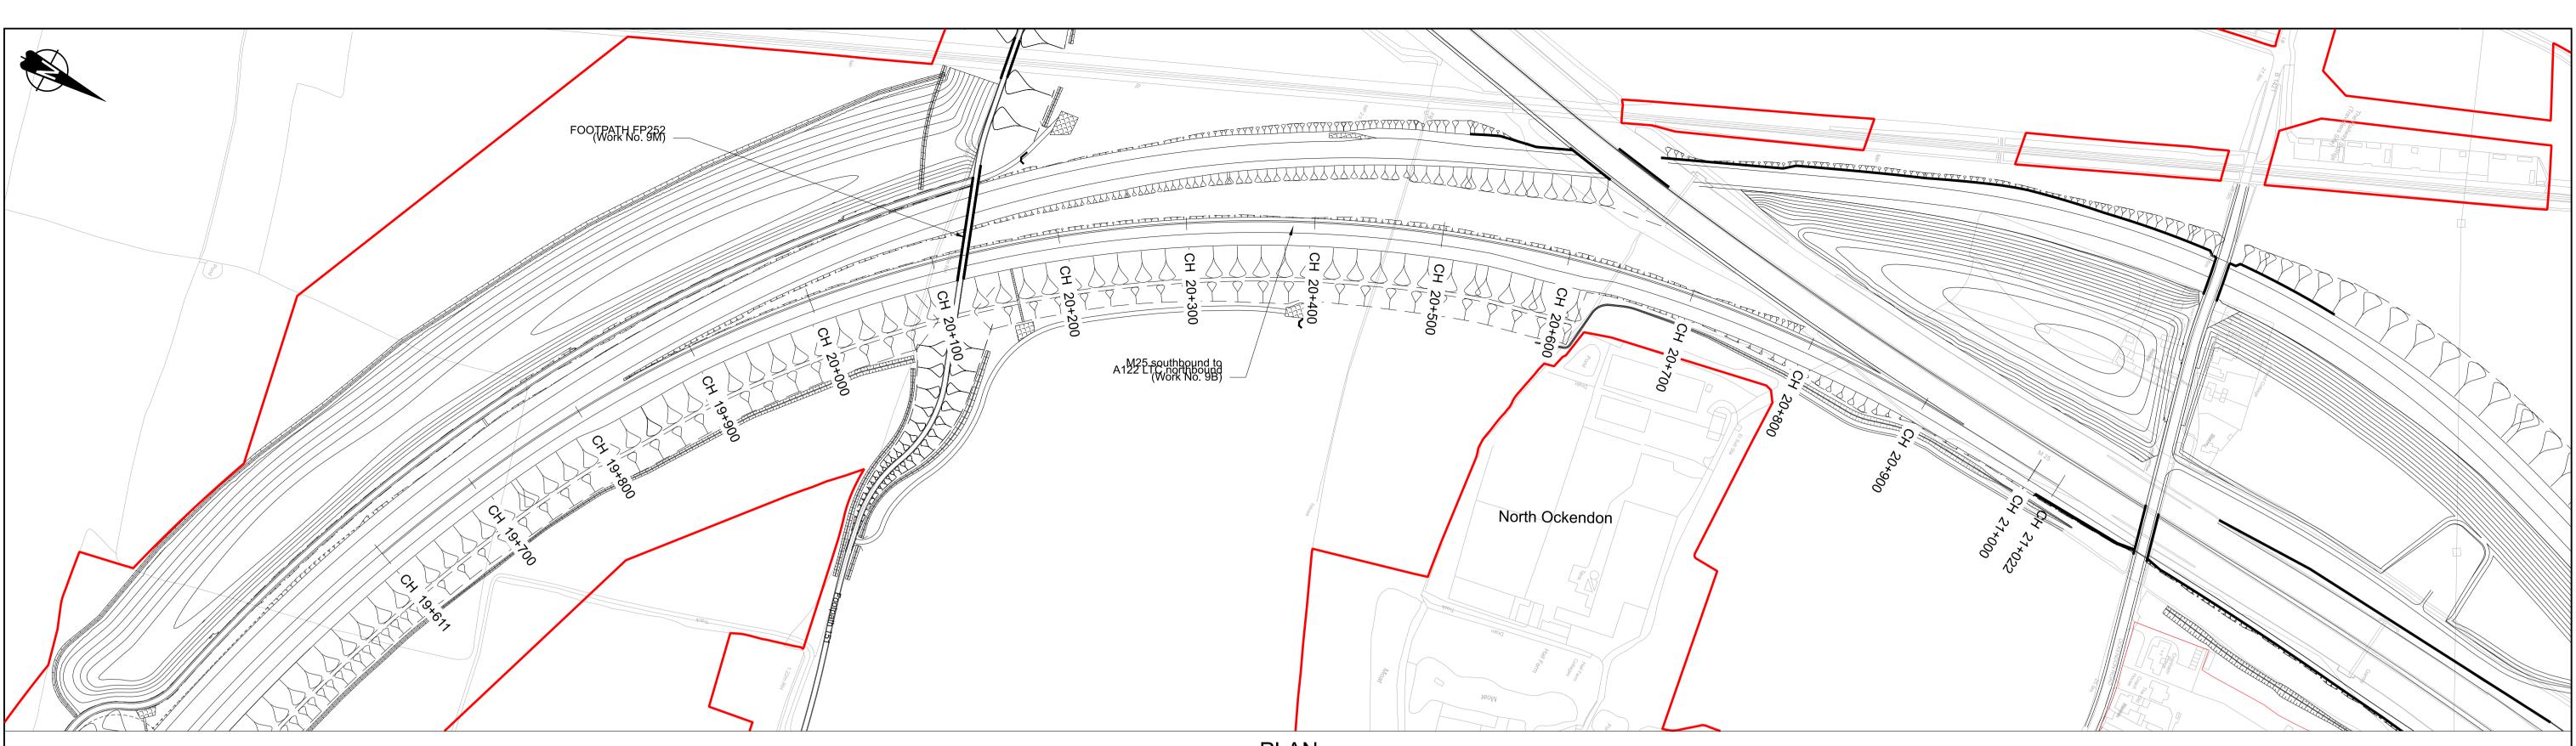
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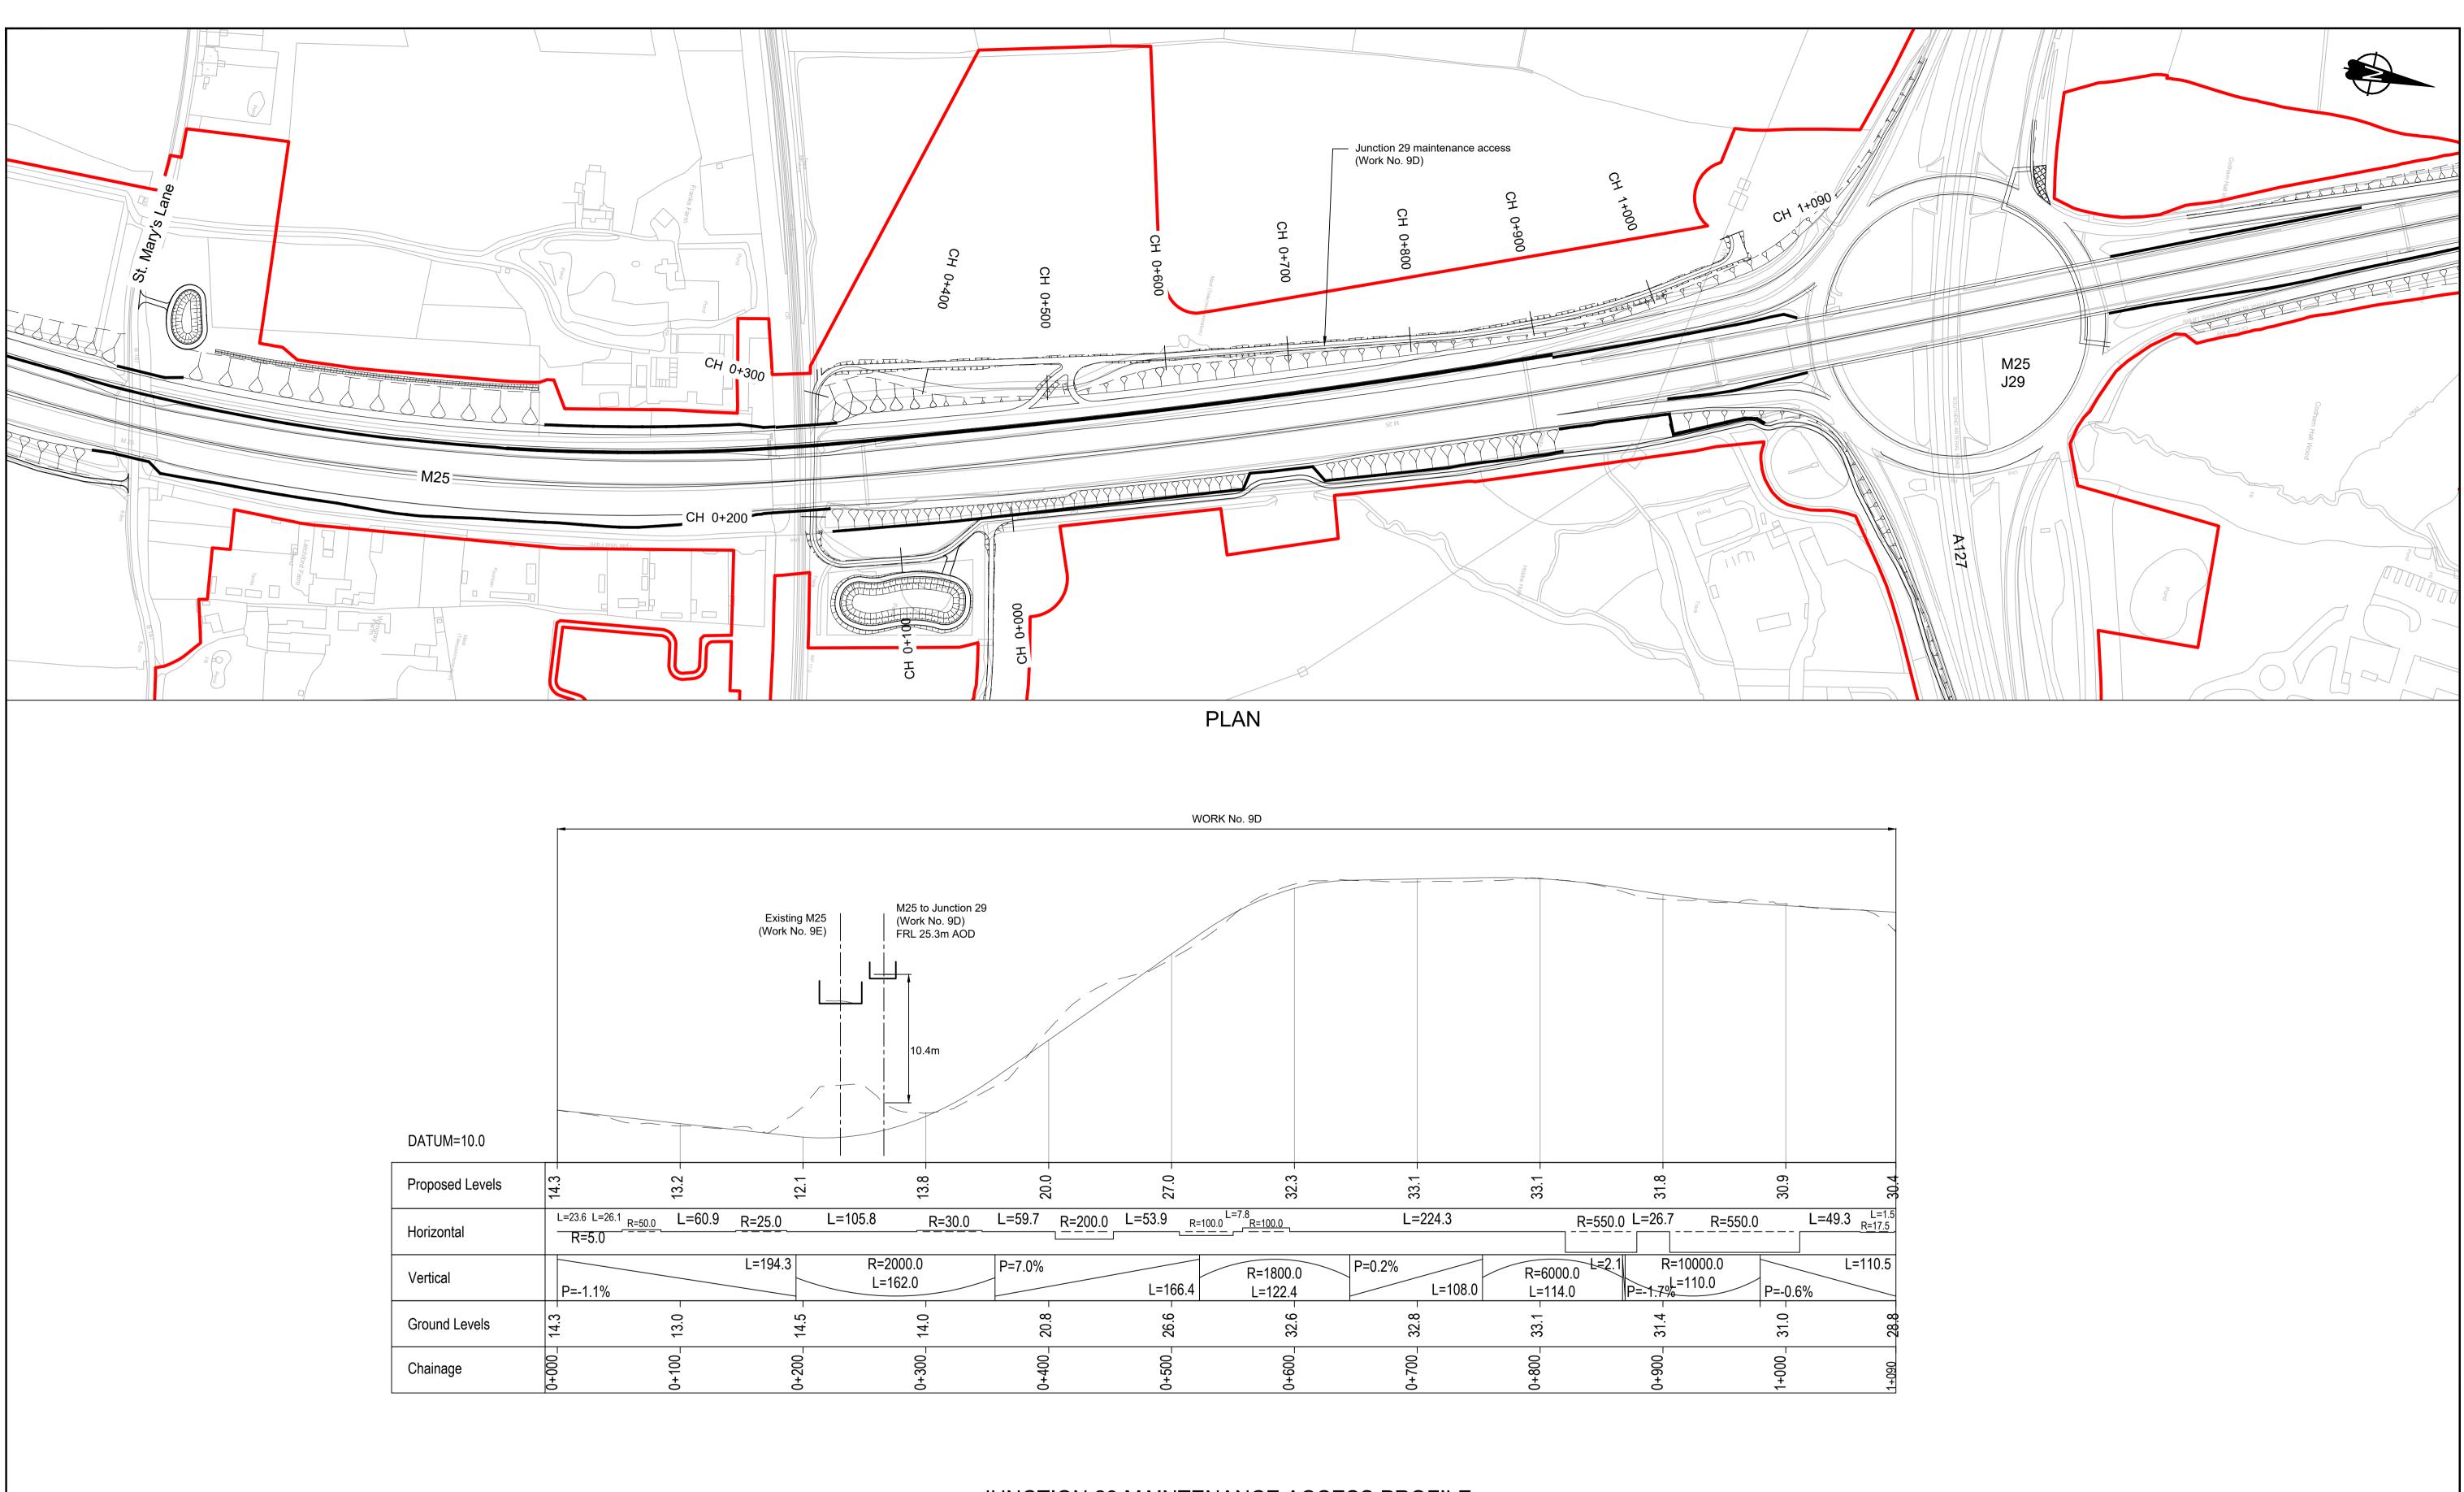


M25 SOUTHBOUND TO A122 LTC SOUTHBOUND PROFILE

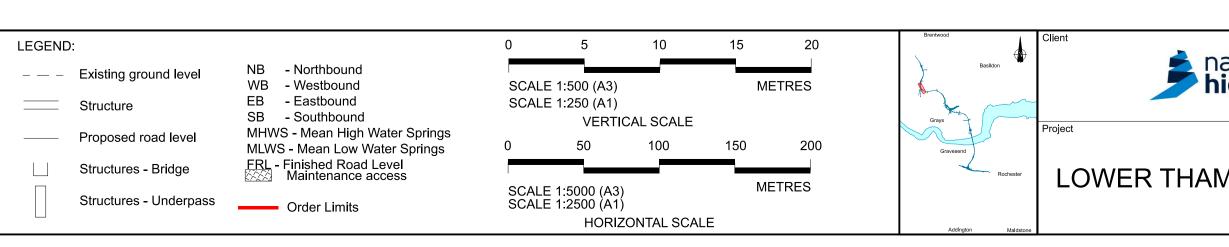

ational	Status DCO Examination	Original Size	Revision P02					
national <b>nighways</b>	Application Document Number TR010032/APP/2.9		SHOWN					
iginayo	Drawing title A122 LTC/M25 JUNCTION							
	REGULATION 5(2)(o) AND	6(2)						
MES CROSSING	SHEET 14							
	Drawing Number HE540039-CJV-BOP-SZA_RX000000DR-CH-10614							
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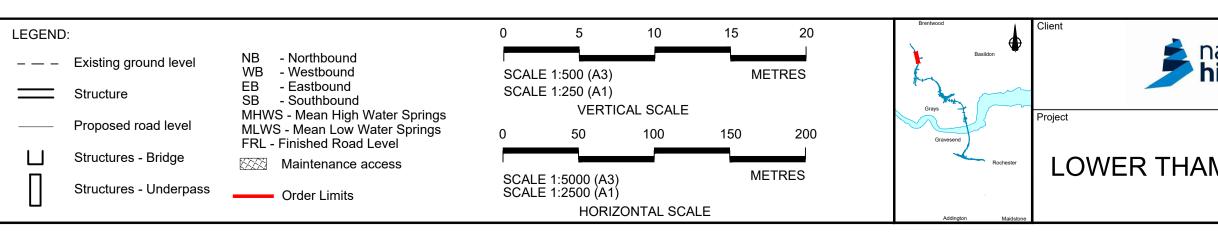


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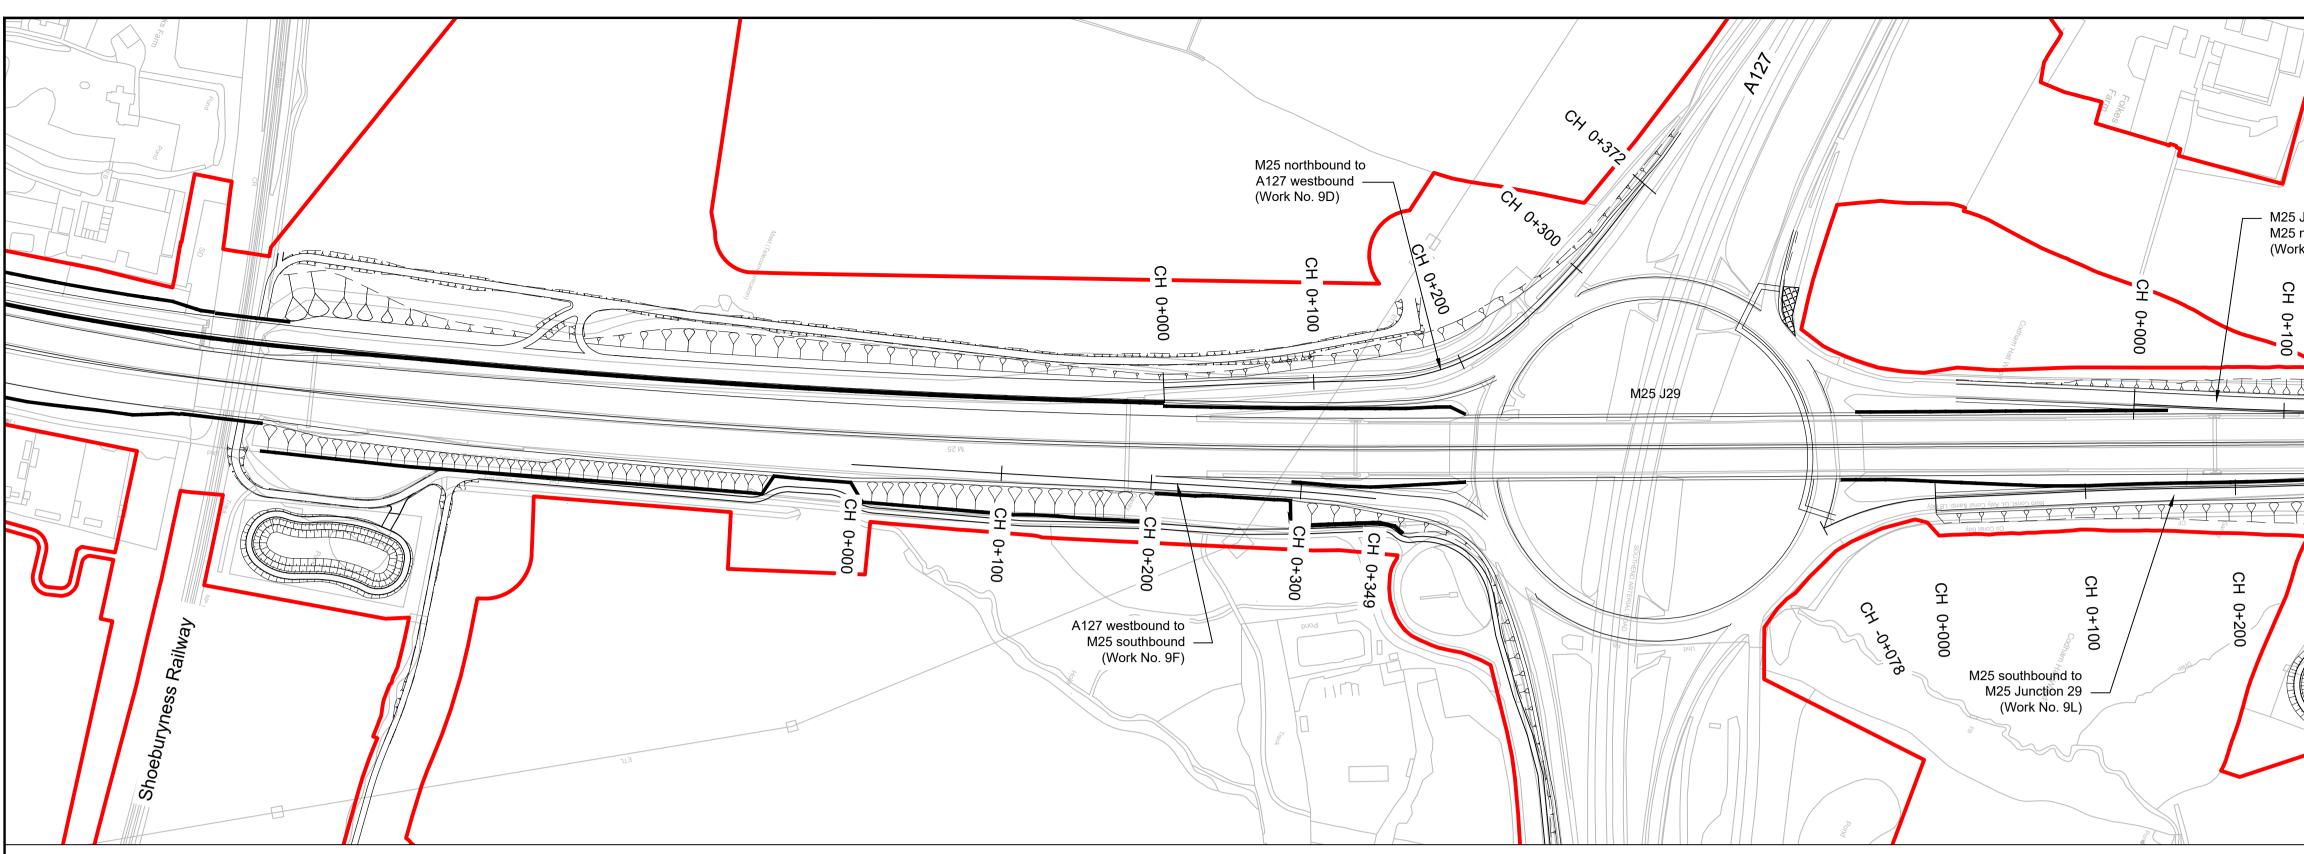
Contains P01 P02	S8 S8	urvey data. © Crown 19/10/2022 11/12/2023	n copyright and database rights 2023. C DCO Application Deadline 9	Drdnance Survey : LY GP	BB RO	ASB	<ol> <li>NOTES:</li> <li>The proposed works shown are illustrative only and will be subject to change as part of detailed design development. Any changes will be limited to being within the constraints included in the Development Consent Order (application document reference TR010032/APP/3.1).</li> <li>These plans should be read in conjunction with Schedule 1 (Authorised Development) of the Development Consent Order (application document reference TR010032/APP/3.1).</li> <li>Do not scale from this drawing.</li> <li>All dimensions are in metres unless stated otherwise.</li> <li>All levels are in metres relative to the Ordnance Datum.</li> <li>Profile uses an exaggerated scale of 1 horizontal : 10 Vertical.</li> </ol>
Rev	Status	Rev. Date	Purpose of revision	Drawn	Chck'd	Apprv'd	


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# JUNCTION 29 MAINTENANCE ACCESS PROFILE



	Status DCO Examination	Original Size	Revision P02				
ational <b>ighways</b>	Application Document Number TR010032/APP/2.9		SHOWN				
	Drawing title A122 LTC/M25 JUNCTIO	N					
	REGULATION 5(2)(0) AND	6(2)					
MES CROSSING	SHEET 15						
	Drawing Number HE540039-CJV-BOP-SZA_RX000000DR-CH-10615						
HE540039-CJV-BOP-SZA_RX000000DR-CH-10615.dwg							



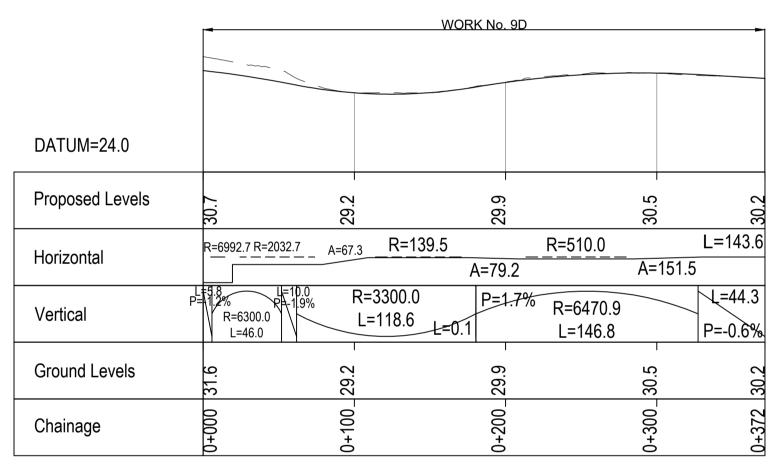


# M25 NORTHBOUND to A127 WESTBOUND PROFILE

	-		WORK No	o. 9F	
DATUM=24.0					
Proposed Levels	29.7	30.6		30.8	29.8
Horizontal		L	.=276.9	R	=1193.1
Vertical	P=2.4 L=21.		R=32 L=16		L=3.6 P=-2.8%
Ground Levels	29.7	30.6		30.8	
Chainage	0+159	0+200_		0+300	0+349


# A127 WESTBOUND to M25 SOUTHBOUND PROFILE

P01 S8 19/10/2022 DCO Application LY BB ASB 4. All dimensions are in metres unless stated otherwise. 5. All levels are in metres relative to the Ordnance Datum.	P01 S8 19/10/2022 DCO Application LY BB P02 S8 11/12/2023 Deadline 9 GP RO	
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1

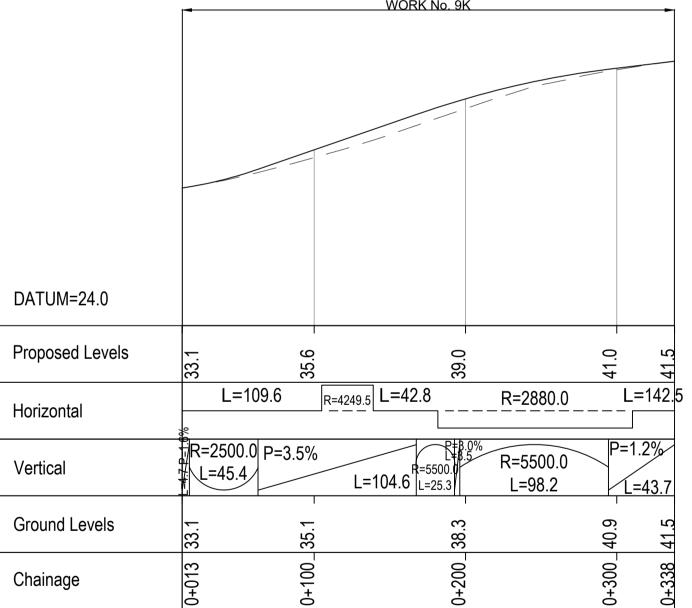

DATUM=24.0	
Proposed Levels	30.9
Horizontal	R=180
Vertical	P=1.5% R=7000.0 L=82.4
Ground Levels	30.9 32.3 _
Chainage	-0+078 30.9 0+000 32.3

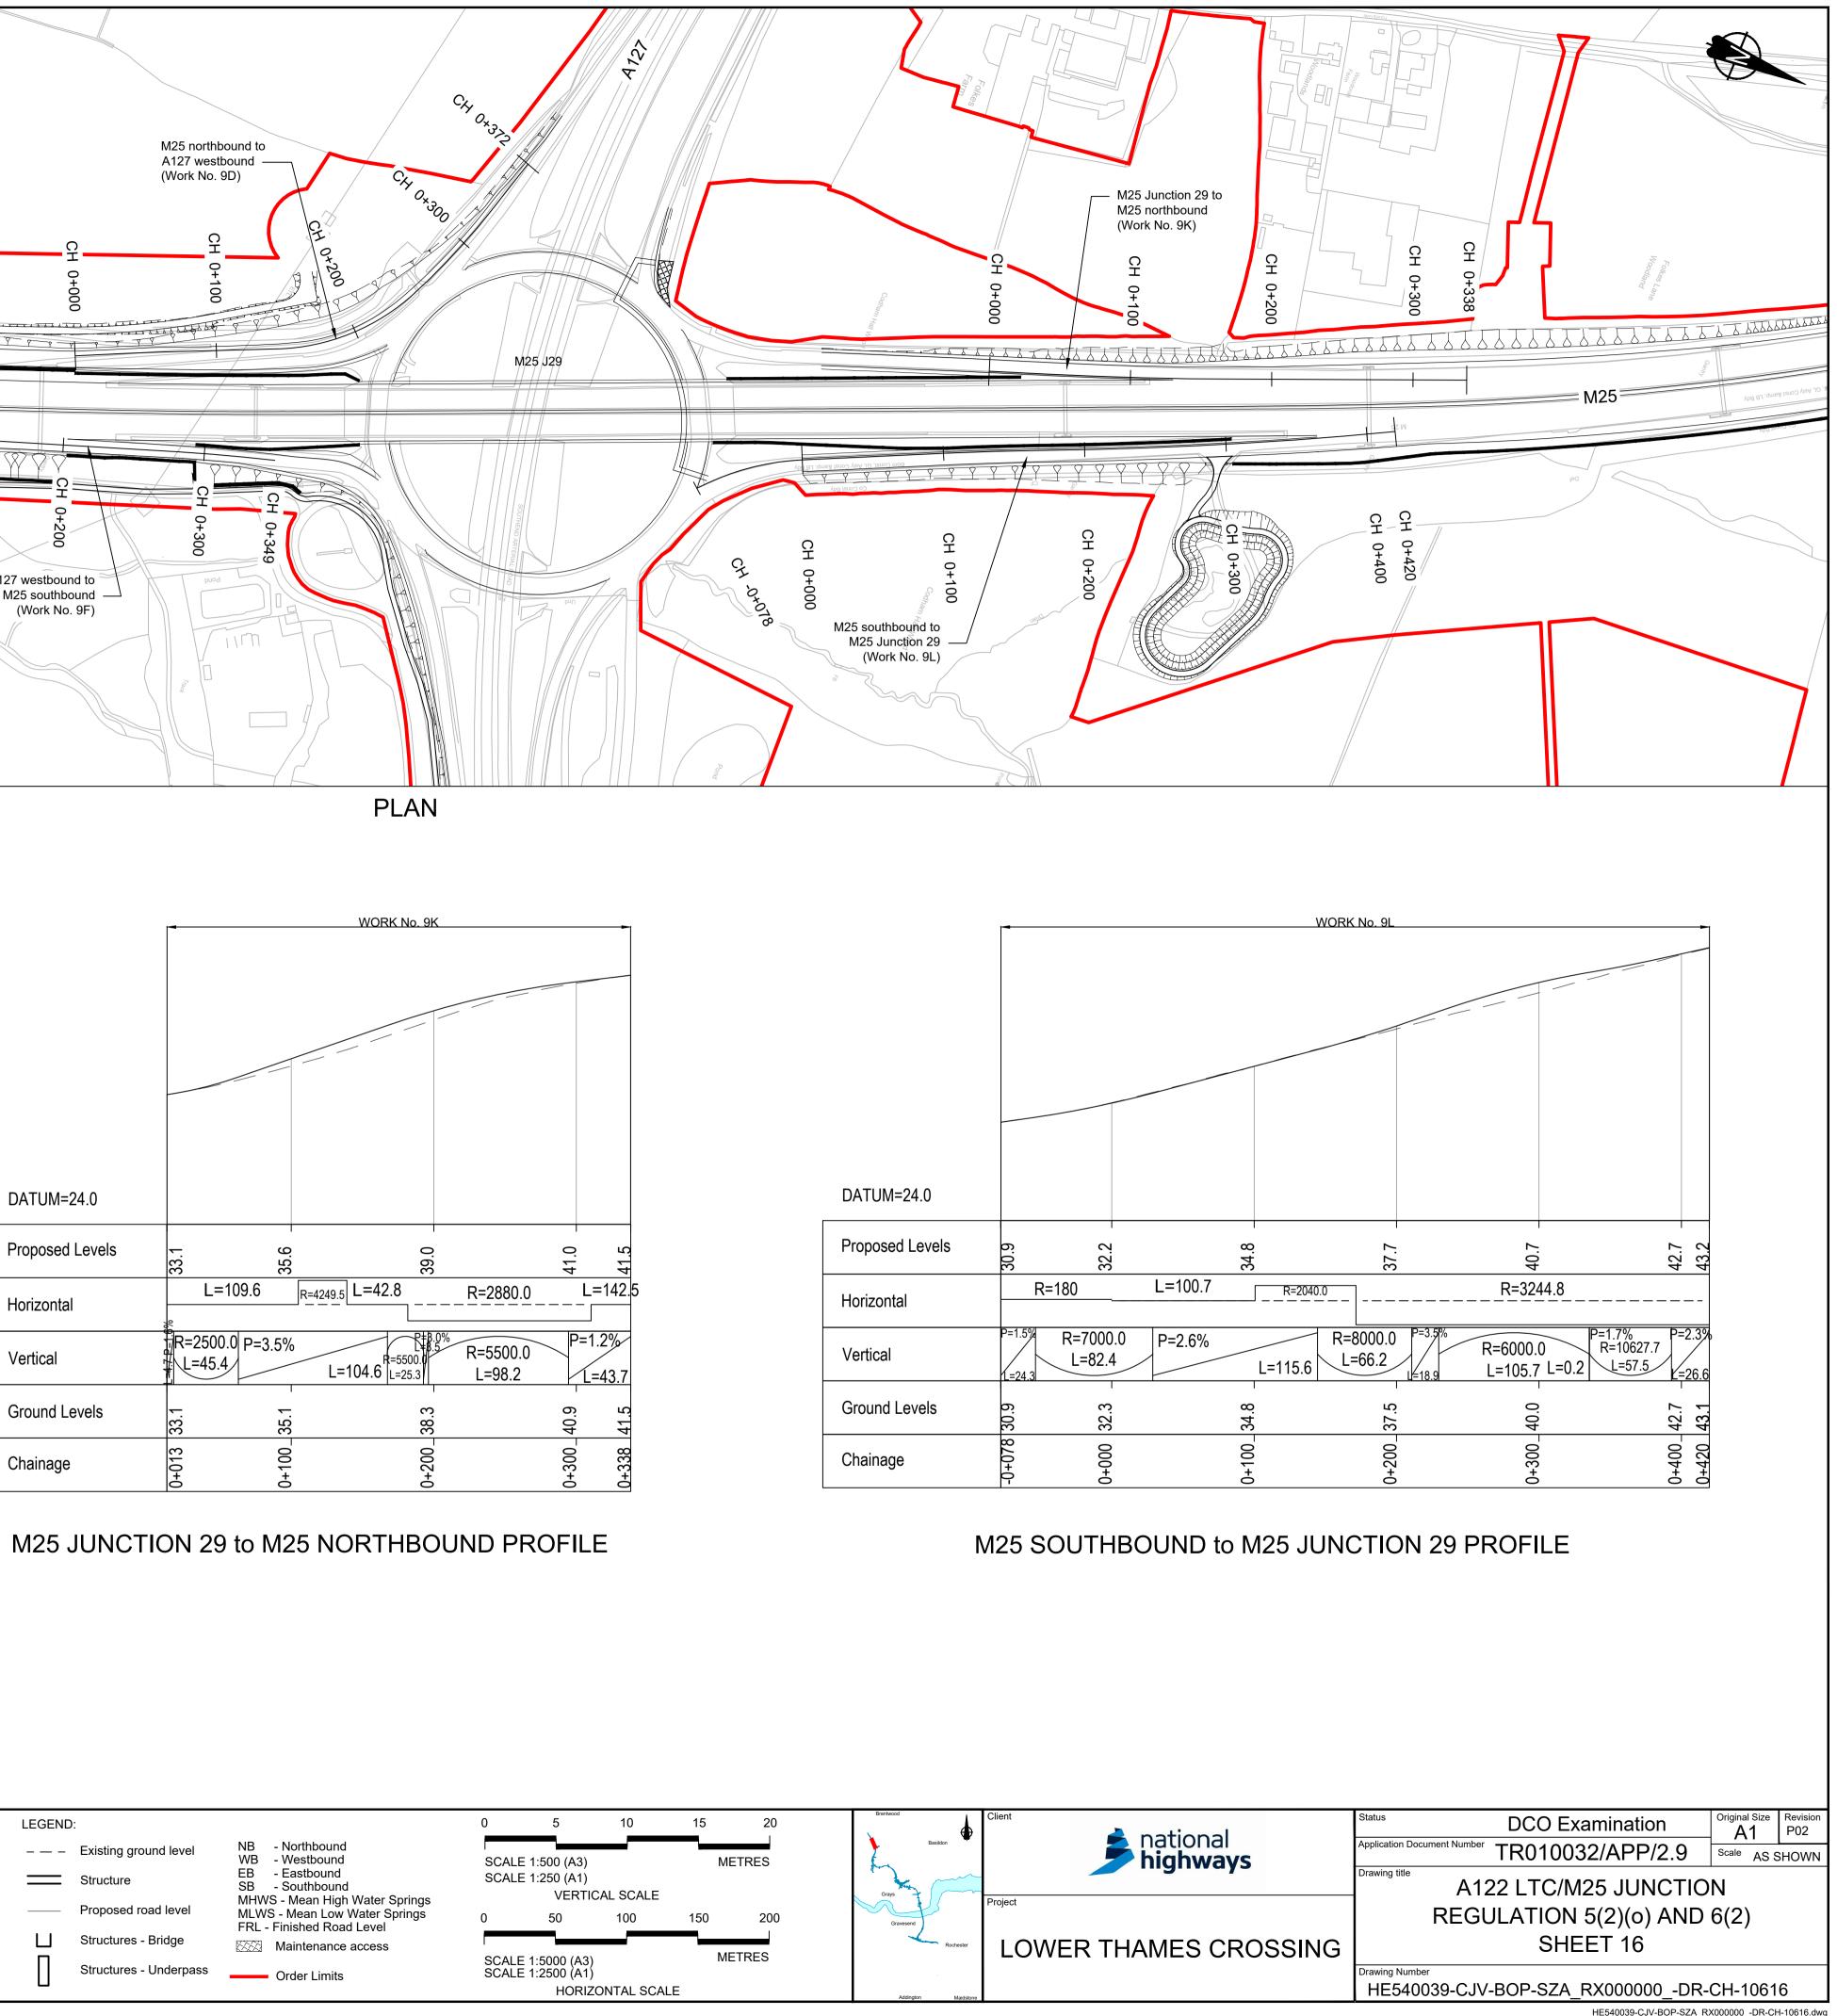

HE540039-CJV-BOP-SZA\_RX000000\_-DR-CH-10616.dwg

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